

UNIVERSITY OF MELBOURNE BUILDING 864 - PERFORMING ARTS





234 ST KILDA ROAD, SOUTHBANK

DRAWING REGISTER


DRAWING TITLE	DRAWING NO	SCALE
COVER PAGE AND DRAWING REGISTER	A0.00	NTS
SITE PLAN	A0.01	1:1000@A3
EXISTING AND DEMOLITION		
EXISTING AND DEMOLITION GROUND FLOOR (LEVEL 1)	A0.10	1:200@A3
EXISTING AND DEMOLITION LEVEL 2	A0.11	1:200@A3
EXISTING AND DEMOLITION LEVEL 3	A0.12	1:200@A3
EXISTING ROOF PLAN	A0.13	1:200@A3
EXISTING AND DEMOLITION REFLECTED CEILING PLAN GROUND FLOOR (LEVEL 1)	A0.14	1:200@A3
EXISTING AND DEMOLITION REFLECTED CEILING PLAN LEVEL 2	A0.15	1:200@A3
EXISTING AND DEMOLITION REFLECTED CEILING PLAN LEVEL 3	A0.16	1:200@A3
EXISTING AND DEMOLITION ELEVATION SOUTH & WEST	A0.50	1:200@A3
EXISTING AND DEMOLITION ELEVATION NORTH	A0.51	1:200@A3
EXISTING AND DEMOLITION SECTION	A0.60	1:200@A3
EXISTING AND DEMOLITION SECTION	A0.61	1:200@A3
EXISTING DETAIL	A0.90	1:5@A3
PROPOSED PLANS		
PROPOSED PLAN GROUND FLOOR (LEVEL 1)	A1.00	1:200@A3
PROPOSED PLAN LEVEL 2	A1.01	1:200@A3
PROPOSED PLAN LEVEL 3	A1.02	1:200@A3
PROPOSED PLAN LEVEL 2 - AMENITIES	A1.10	1:100@A3
PROPOSED ROOF PLAN	A1.20	1:200@A3
PROPOSED REFLECTED CEILING PLAN GROUND FLOOR (LEVEL 1)	A3.00	1:200@A3
PROPOSED REFLECTED CEILING PLAN LEVEL 2	A3.01	1:200@A3
PROPOSED REFLECTED CEILING PLAN LEVEL 3	A3.02	1:200@A3
PROPOSED PLAN LEVEL 2 - AMENITIES FITOUT	A4.00	1:100@A3
PROPOSED ELEVATION & SECTION		
PROPOSED ELEVATION SOUTH & WEST	A5.02	1:200@A3
PROPOSED ELEVATION NORTH	A5.03	1:200@A3
PROPOSED SECTION	A6.00	1:200@A3
PROPOSED SECTION	A6.01	1:200@A3
DETAILS		
PROPOSED LIFT DETAILS	A10.00	1:20@A3
PROPOSED LIFT DETAILS	A10.01	1:20@A3
PROPOSED LIFT SECTION DETAILS	A10.02	1:50@A3
PROPOSED BRIDGE LINK DETAILS	A10.10	1:50@A3
PROPOSED BRIDGE LINK DETAILS	A10.11	1:20/1:50@A3
MATERIALITY		
EXISTING EXTERNAL VIEW	A20.00	NTS
PROPOSED EXTERNAL VIEW	A20.01	NTS
PROPOSED EXTERNAL MATERIALS	A20.02	NTS




1 PROPOSED BRIDGE VIEW




<small>ALL DIMENSIONS AND LEVELS TO BE VERIFIED ON SITE BY THE BUILDER BEFORE THE COMMENCEMENT OF ANY WORK. ANY DISCREPANCIES MUST BE REPORTED TO THE ARCHITECT IMMEDIATELY. DO NOT SCALE DRAWINGS. FIGURED DIMENSIONS HAVE PREFERENCE OVER DIMENSIONS SCALED FROM THE DRAWINGS. THESE DRAWINGS TO BE READ IN CONJUNCTION WITH THE SPECIFICATIONS AND OTHER ASSOCIATED DOCUMENTS. REFER TO ENGINEERING SERVICES DRAWINGS FOR CONFIRMATION OF LOCATIONS AND HEIGHT OF FITTINGS, AIR DIFFUSERS, GRILLES, SPRINKLERS, SMOKE DETECTORS, AND ALL OTHER CEILING MOUNTED OR RECESSED SERVICE OUTLETS AND FITTINGS AND ADDITIONAL SET OUT OF CEILING SUPPORT MEMBERS. MAKE ALL PENETRATIONS, CUT OUTS AND TRIM TO SUIT ALL RELEVANT SERVICE OUTLETS AND FITTINGS. ANY DISCREPANCIES BETWEEN THE ARCHITECTURAL AND SERVICES DOCUMENTS ARE TO BE REPORTED TO THE ARCHITECT FOR CLARIFICATION. IN THE EVENT OF DISCREPANCIES, THE CONTRACTOR MUST ALLOW FOR THE HIGHER COST ALTERNATIVE IN THE SCOPE OF WORKS. NOM INDICATES A NOMINAL DIMENSION TO BE CHECKED ON SITE.</small>	<table border="1"> <thead> <tr> <th>REV</th> <th>DESCRIPTION</th> <th>DRAWN</th> <th>DATE</th> </tr> </thead> <tbody> <tr> <td>1</td> <td>FOR COORDINATION</td> <td></td> <td>08.02.2024</td> </tr> <tr> <td>2</td> <td>FOR COORDINATION</td> <td></td> <td>29.02.2024</td> </tr> <tr> <td>3</td> <td>FOR COORDINATION</td> <td></td> <td>06.03.2024</td> </tr> <tr> <td>4</td> <td>FOR HERITAGE PERMIT</td> <td></td> <td>10.05.2024</td> </tr> </tbody> </table>	REV	DESCRIPTION	DRAWN	DATE	1	FOR COORDINATION		08.02.2024	2	FOR COORDINATION		29.02.2024	3	FOR COORDINATION		06.03.2024	4	FOR HERITAGE PERMIT		10.05.2024	<table border="1"> <thead> <tr> <th>CLIENT</th> </tr> </thead> <tbody> <tr> <td>  VICTORIAN COLLEGE OF THE ARTS The University of Melbourne </td> </tr> </tbody> </table>	CLIENT	 VICTORIAN COLLEGE OF THE ARTS The University of Melbourne	<table border="1"> <tbody> <tr> <td> SERVICES ENGINEERING Caleb Engineers 206 / 7 Jelfcott St, West Melbourne, VIC 3003. Ph. 9020 9347 </td> <td> BUILDING SURVEYOR Wilmore Nelson McDermott Suite 105/80 Monash Dr, Dandenong South, VIC 3175. Ph. 1300 799 543 </td> </tr> <tr> <td> STRUCTURAL ENGINEERING Engineering Folk 0413 516 870 </td> <td> COST CONSULTANT </td> </tr> </tbody> </table>	SERVICES ENGINEERING Caleb Engineers 206 / 7 Jelfcott St, West Melbourne, VIC 3003. Ph. 9020 9347	BUILDING SURVEYOR Wilmore Nelson McDermott Suite 105/80 Monash Dr, Dandenong South, VIC 3175. Ph. 1300 799 543	STRUCTURAL ENGINEERING Engineering Folk 0413 516 870	COST CONSULTANT		<table border="1"> <tbody> <tr> <td> PROJECT UNIVERSITY OF MELBOURNE BLDG 864 - PERFORMING ARTS </td> <td> DRAWN BY H2o </td> <td> SCALE NTS </td> <td> PLOT DATE 10.05.2024 </td> </tr> <tr> <td> DRAWING TITLE COVER PAGE & DRAWING REGISTER </td> <td> PROJECT NUMBER 2356 </td> <td> FOR HERITAGE PERMIT </td> <td> DRAWING NUMBER A0.00 </td> </tr> <tr> <td></td> <td></td> <td> REVISION 4 </td> <td></td> </tr> </tbody> </table>	PROJECT UNIVERSITY OF MELBOURNE BLDG 864 - PERFORMING ARTS	DRAWN BY H2o	SCALE NTS	PLOT DATE 10.05.2024	DRAWING TITLE COVER PAGE & DRAWING REGISTER	PROJECT NUMBER 2356	FOR HERITAGE PERMIT	DRAWING NUMBER A0.00			REVISION 4	
	REV	DESCRIPTION	DRAWN	DATE																																							
1	FOR COORDINATION		08.02.2024																																								
2	FOR COORDINATION		29.02.2024																																								
3	FOR COORDINATION		06.03.2024																																								
4	FOR HERITAGE PERMIT		10.05.2024																																								
CLIENT																																											
 VICTORIAN COLLEGE OF THE ARTS The University of Melbourne																																											
SERVICES ENGINEERING Caleb Engineers 206 / 7 Jelfcott St, West Melbourne, VIC 3003. Ph. 9020 9347	BUILDING SURVEYOR Wilmore Nelson McDermott Suite 105/80 Monash Dr, Dandenong South, VIC 3175. Ph. 1300 799 543																																										
STRUCTURAL ENGINEERING Engineering Folk 0413 516 870	COST CONSULTANT																																										
PROJECT UNIVERSITY OF MELBOURNE BLDG 864 - PERFORMING ARTS	DRAWN BY H2o	SCALE NTS	PLOT DATE 10.05.2024																																								
DRAWING TITLE COVER PAGE & DRAWING REGISTER	PROJECT NUMBER 2356	FOR HERITAGE PERMIT	DRAWING NUMBER A0.00																																								
		REVISION 4																																									

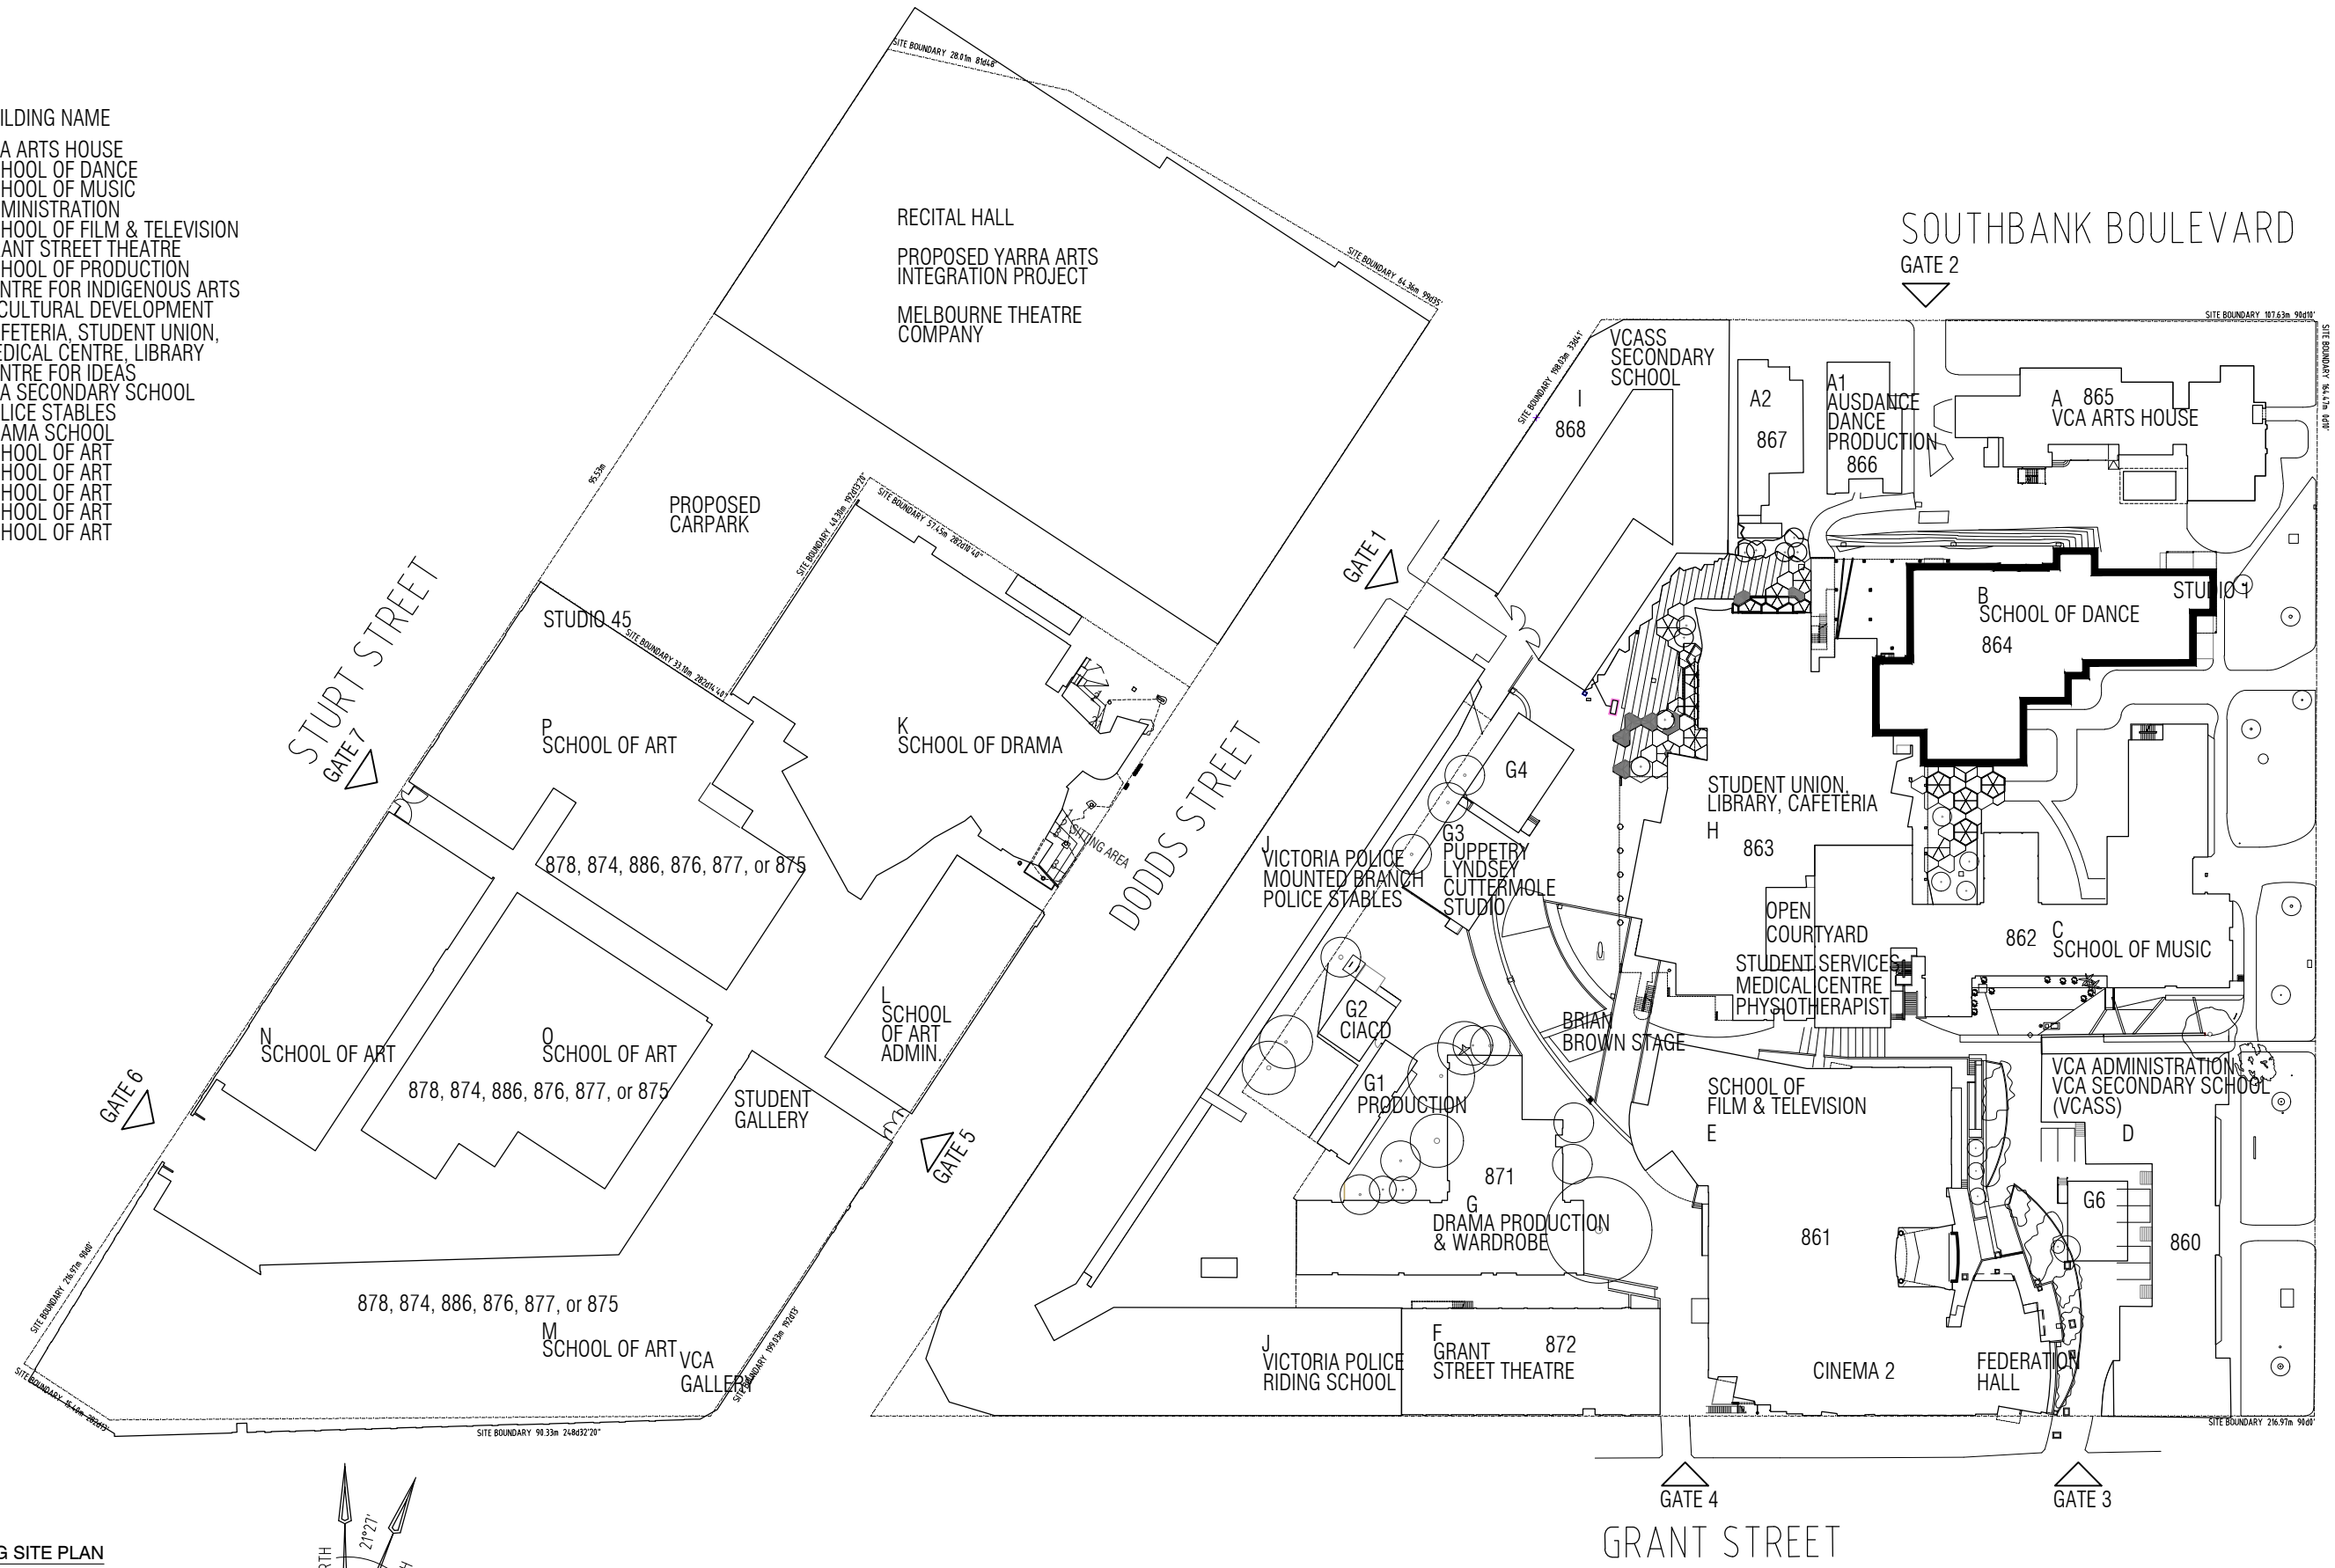
- LEGEND**
- INDEX BUILDING NAME
- A – VCA ARTS HOUSE
 - B – SCHOOL OF DANCE
 - C – SCHOOL OF MUSIC
 - D – ADMINISTRATION
 - E – SCHOOL OF FILM & TELEVISION
 - F – GRANT STREET THEATRE
 - G – SCHOOL OF PRODUCTION
 - G2 – CENTRE FOR INDIGENOUS ARTS & CULTURAL DEVELOPMENT
 - H – CAFETERIA, STUDENT UNION, MEDICAL CENTRE, LIBRARY
 - I – CENTRE FOR IDEAS
 - J – VCA SECONDARY SCHOOL
 - K – POLICE STABLES
 - L – DRAMA SCHOOL
 - M – SCHOOL OF ART
 - N – SCHOOL OF ART
 - O – SCHOOL OF ART
 - P – SCHOOL OF ART

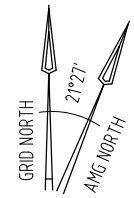

1 EXISTING SITE PLAN
1:1000@A3



<p>ALL DIMENSIONS AND LEVELS TO BE VERIFIED ON SITE BY THE BUILDER BEFORE THE COMMENCEMENT OF ANY WORK. ANY DISCREPANCIES MUST BE REPORTED TO THE ARCHITECT IMMEDIATELY. DO NOT SCALE DRAWINGS. FIGURED DIMENSIONS HAVE PREFERENCE OVER DIMENSIONS SCALED FROM THE DRAWINGS. THESE DRAWINGS TO BE READ IN CONJUNCTION WITH THE SPECIFICATIONS AND OTHER ASSOCIATED DOCUMENTS. REFER TO ENGINEERING SERVICES DRAWINGS FOR CONFIRMATION OF LOCATIONS AND HEIGHT OF FITTINGS, AIR DIFFUSERS, GRILLES, SPRINKLERS, SMOKE DETECTORS, AND ALL OTHER CEILING MOUNTED OR RECESSED SERVICE OUTLETS AND FITTINGS AND ADDITIONAL SET OUT OF CEILING SUPPORT MEMBERS. MAKE ALL PENETRATIONS, CUT OUTS AND TRIM TO SUIT ALL RELEVANT SERVICE OUTLETS AND FITTINGS. ANY DISCREPANCIES BETWEEN THE ARCHITECTURAL AND SERVICES DOCUMENTS ARE TO BE REPORTED TO THE ARCHITECT FOR CLARIFICATION. IN THE EVENT OF DISCREPANCIES, THE CONTRACTOR MUST ALLOW FOR THE HIGHER COST ALTERNATIVE IN THE SCOPE OF WORKS. NOM INDICATES A NOMINAL DIMENSION TO BE CHECKED ON SITE.</p>	<table border="1"> <thead> <tr> <th>REV</th> <th>DESCRIPTION</th> <th>DRAWN</th> <th>DATE</th> </tr> </thead> <tbody> <tr> <td>1</td> <td>FOR HERITAGE PERMIT</td> <td></td> <td>10.05.2024</td> </tr> </tbody> </table>	REV	DESCRIPTION	DRAWN	DATE	1	FOR HERITAGE PERMIT		10.05.2024	<p>CLIENT</p>  <p>VICTORIAN COLLEGE OF THE ARTS The University of Melbourne</p>	<p>SERVICES ENGINEERING Caleb Engineers 206 / 7 Jelfcott St, West Melbourne, VIC 3003. Ph. 9020 9347</p> <p>STRUCTURAL ENGINEERING Engineering Folk 0413 516 870</p>	<p>BUILDING SURVEYOR Wilmore Nelson McDermott Suite 105/80 Monash Dr, Dandenong South, VIC 3175. Ph. 1300 799 543</p> <p>COST CONSULTANT</p>	 <p>H2o architects Pty Ltd 29 Northumberland Street Collingwood Victoria 3066 Australia T 61 3 9417 0900 F 61 3 9417 0911 studio@h2oarchitects.com.au</p>	<p>PROJECT UNIVERSITY OF MELBOURNE BLDG 864 - PERFORMING ARTS</p> <p>DRAWING TITLE EXISTING SITE PLAN</p>	<p>DRAWN BY H2o</p> <p>PROJECT NUMBER 2356</p> 	<p>SCALE 1:1000 @ A3</p> <p>PLOT DATE 10.05.2024</p> <p>FOR HERITAGE PERMIT</p>	<p>DRAWING NUMBER A0.01</p> <p>REVISION 1</p>
	REV	DESCRIPTION	DRAWN	DATE													
1	FOR HERITAGE PERMIT		10.05.2024														

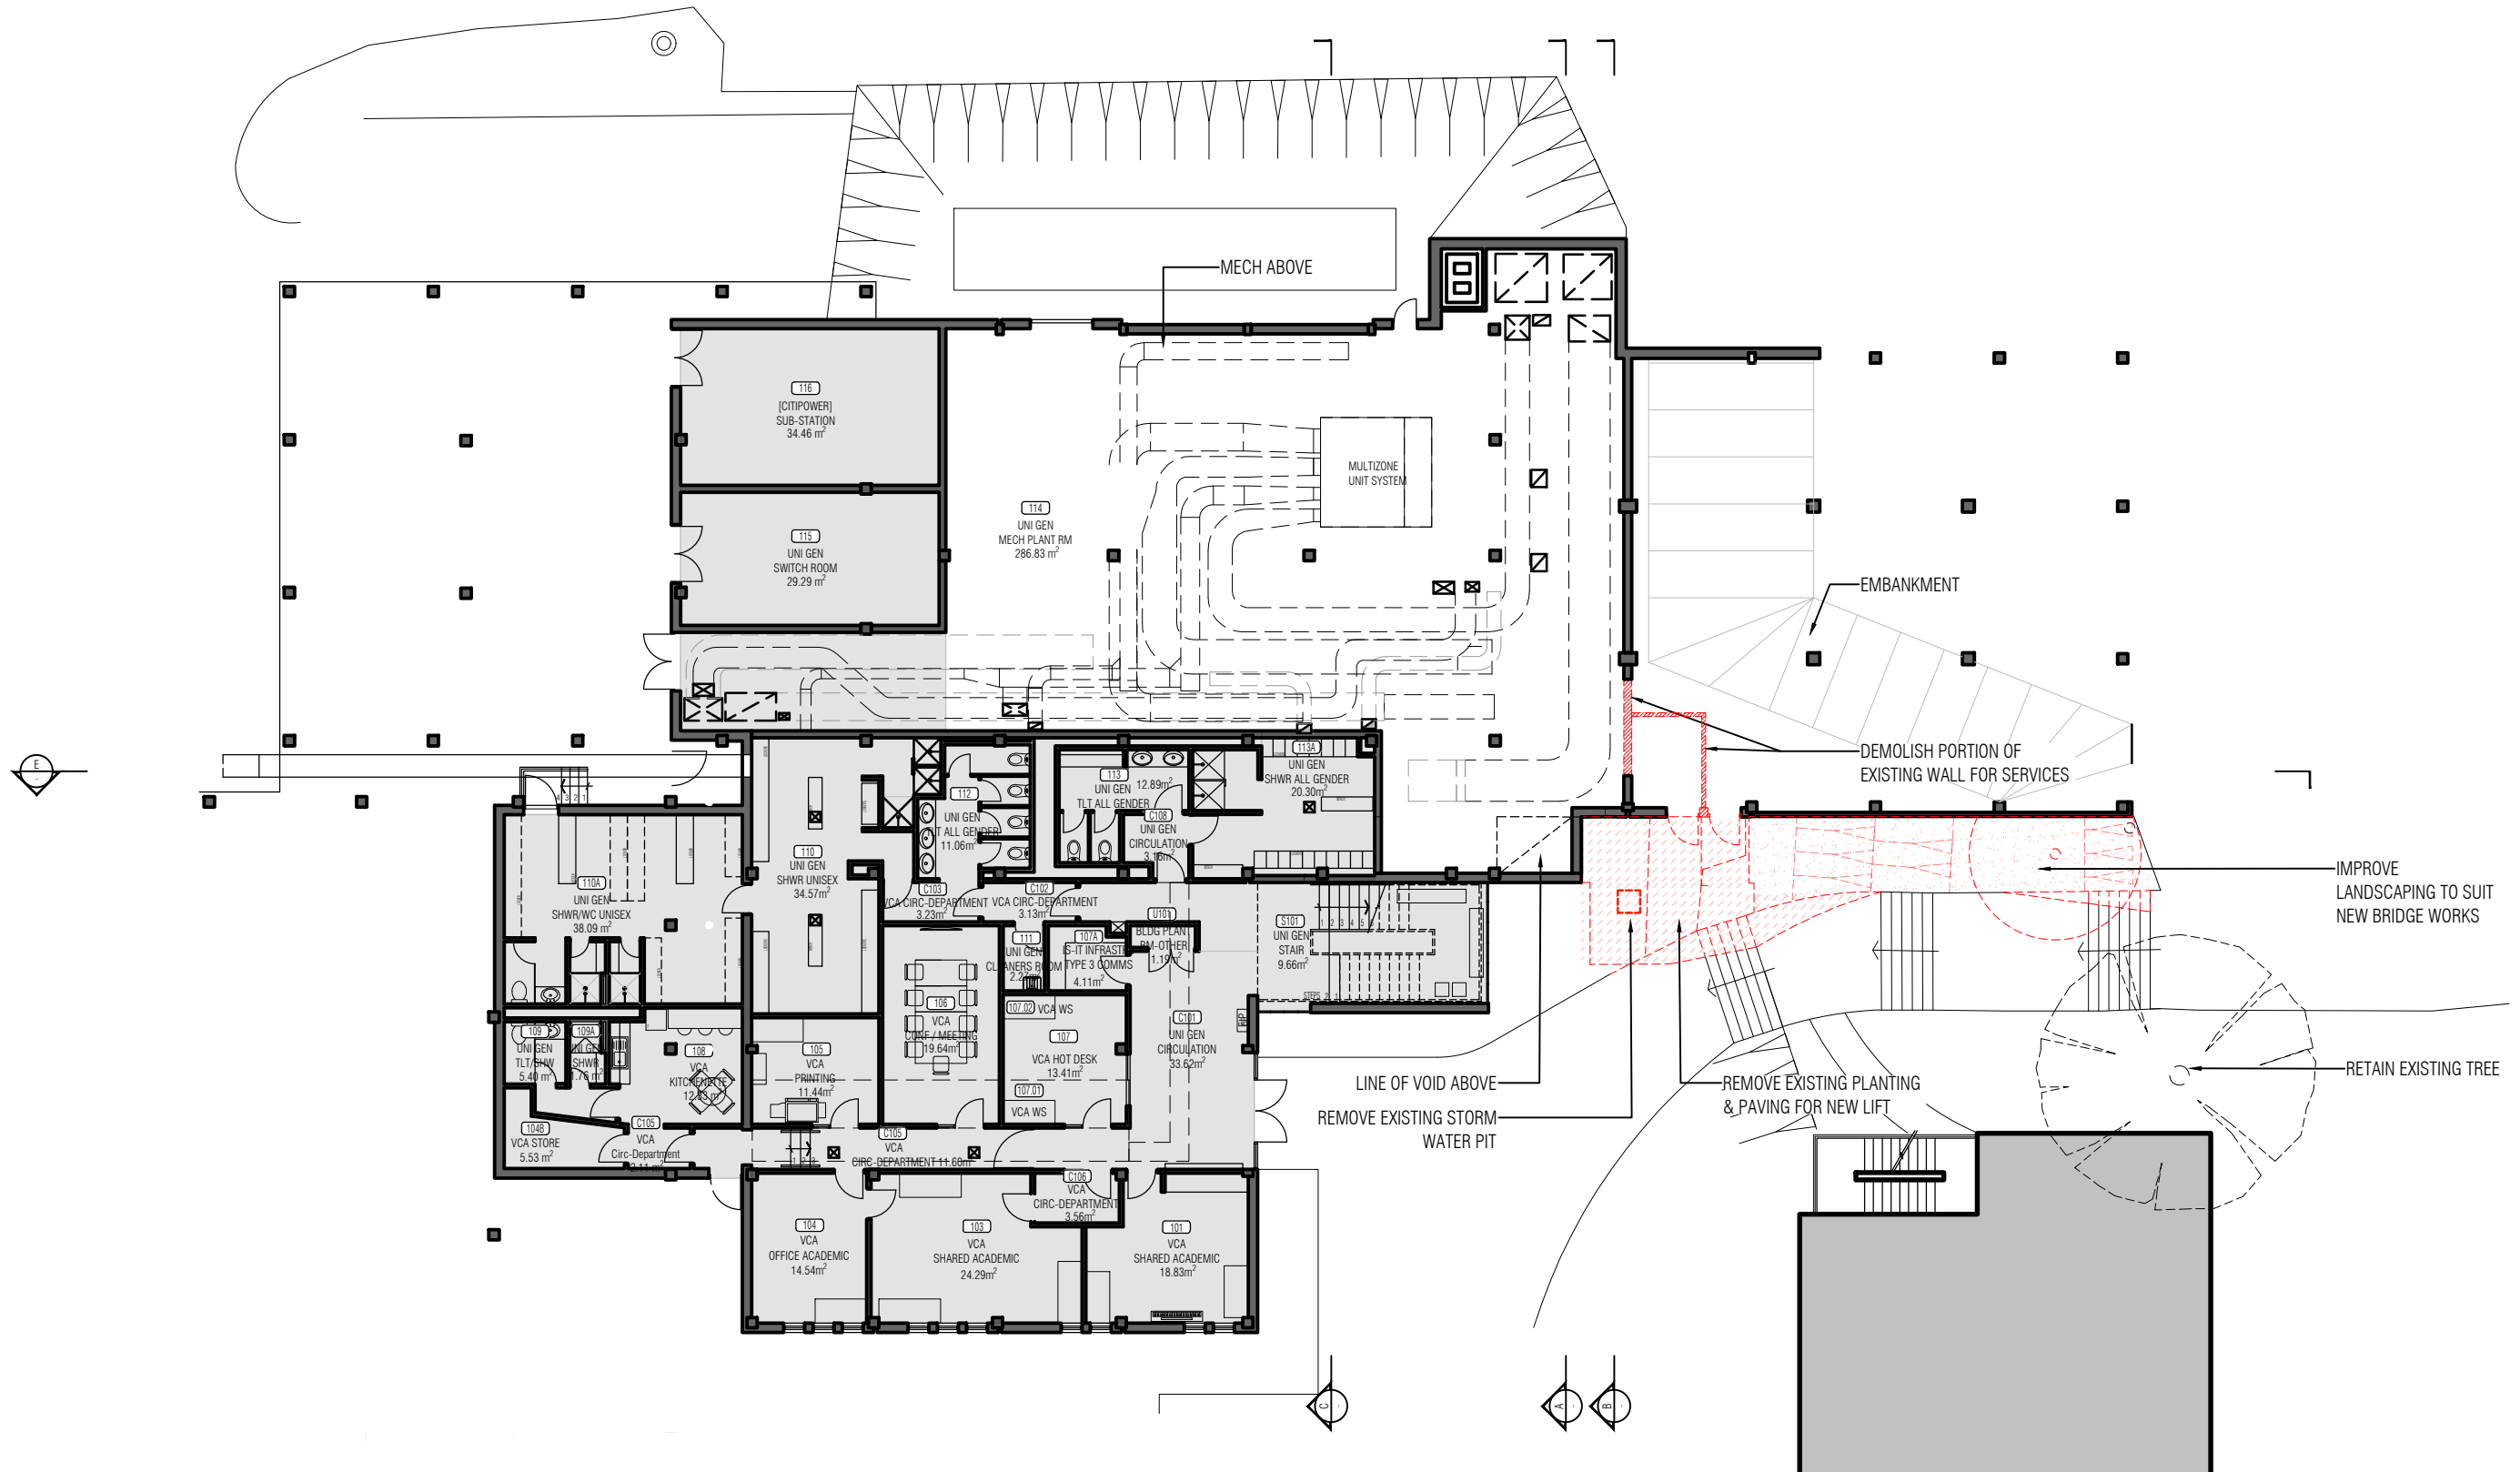

1 EXISTING PLAN - GROUND FLOOR (LEVEL 1)
1:200@A3

- DEMOLITION
- FLOOR FINISHES TO BE DEMOLISHED
- OUT OF SCOPE

ALL DIMENSIONS AND LEVELS TO BE VERIFIED ON SITE BY THE BUILDER BEFORE THE COMMENCEMENT OF ANY WORK. ANY DISCREPANCIES MUST BE REPORTED TO THE ARCHITECT IMMEDIATELY. DO NOT SCALE DRAWINGS. FIGURED DIMENSIONS HAVE PREFERENCE OVER DIMENSIONS SCALED FROM THE DRAWINGS. THESE DRAWINGS TO BE READ IN CONJUNCTION WITH THE SPECIFICATIONS AND OTHER ASSOCIATED DOCUMENTS. REFER TO ENGINEERING SERVICES DRAWINGS FOR CONFIRMATION OF LOCATIONS AND HEIGHT OF FITTINGS, AIR DIFFUSERS, GRILLES, SPRINKLERS, SMOKE DETECTORS, AND ALL OTHER CEILING MOUNTED OR RECESSED SERVICE OUTLETS AND FITTINGS AND ADDITIONAL SET OUT OF CEILING SUPPORT MEMBERS. MAKE ALL PENETRATIONS, CUT OUTS AND TRIM TO SUIT ALL RELEVANT SERVICE OUTLETS AND FITTINGS. ANY DISCREPANCIES BETWEEN THE ARCHITECTURAL AND SERVICES DOCUMENTS ARE TO BE REPORTED TO THE ARCHITECT FOR CLARIFICATION. IN THE EVENT OF DISCREPANCIES, THE CONTRACTOR MUST ALLOW FOR THE HIGHER COST ALTERNATIVE IN THE SCOPE OF WORKS. NOM INDICATES A NOMINAL DIMENSION TO BE CHECKED ON SITE.

REV	DESCRIPTION	DRAWN	DATE
1	FOR COORDINATION	-	08.02.2024
2	FOR COORDINATION	-	29.02.2024
3	FOR COORDINATION	-	06.03.2024
4	FOR HERITAGE PERMIT	-	10.05.2024

CLIENT

SERVICES ENGINEERING
Caleb Engineers
206 / 7 Jelfcott St,
West Melbourne, VIC 3003.
Ph. 9020 9347

BUILDING SURVEYOR
Wilmore Nelson McDermott
Suite 105/80 Monash Dr,
Dandenong South, VIC 3175.
Ph. 1300 799 543

STRUCTURAL ENGINEERING
Engineering Folk
0413 516 870

COST CONSULTANT

H2o architects Pty Ltd
29 Northumberland Street
Collingwood
Victoria 3066 Australia
T 61 3 9417 0900
F 61 3 9417 0911
studio@h2oarchitects.com.au

PROJECT
**UNIVERSITY OF MELBOURNE
BLDG 864 - PERFORMING ARTS**

DRAWING TITLE
**EXISTING & DEMO PLAN
GROUND FLOOR (LEVEL 1)**

DRAWN BY
H2o

PROJECT NUMBER
2356

SCALE
1:200 @ A3


PLOT DATE
10.05.2024

FOR HERITAGE PERMIT

DRAWING NUMBER
A0.10

REVISION
4

7 7 7

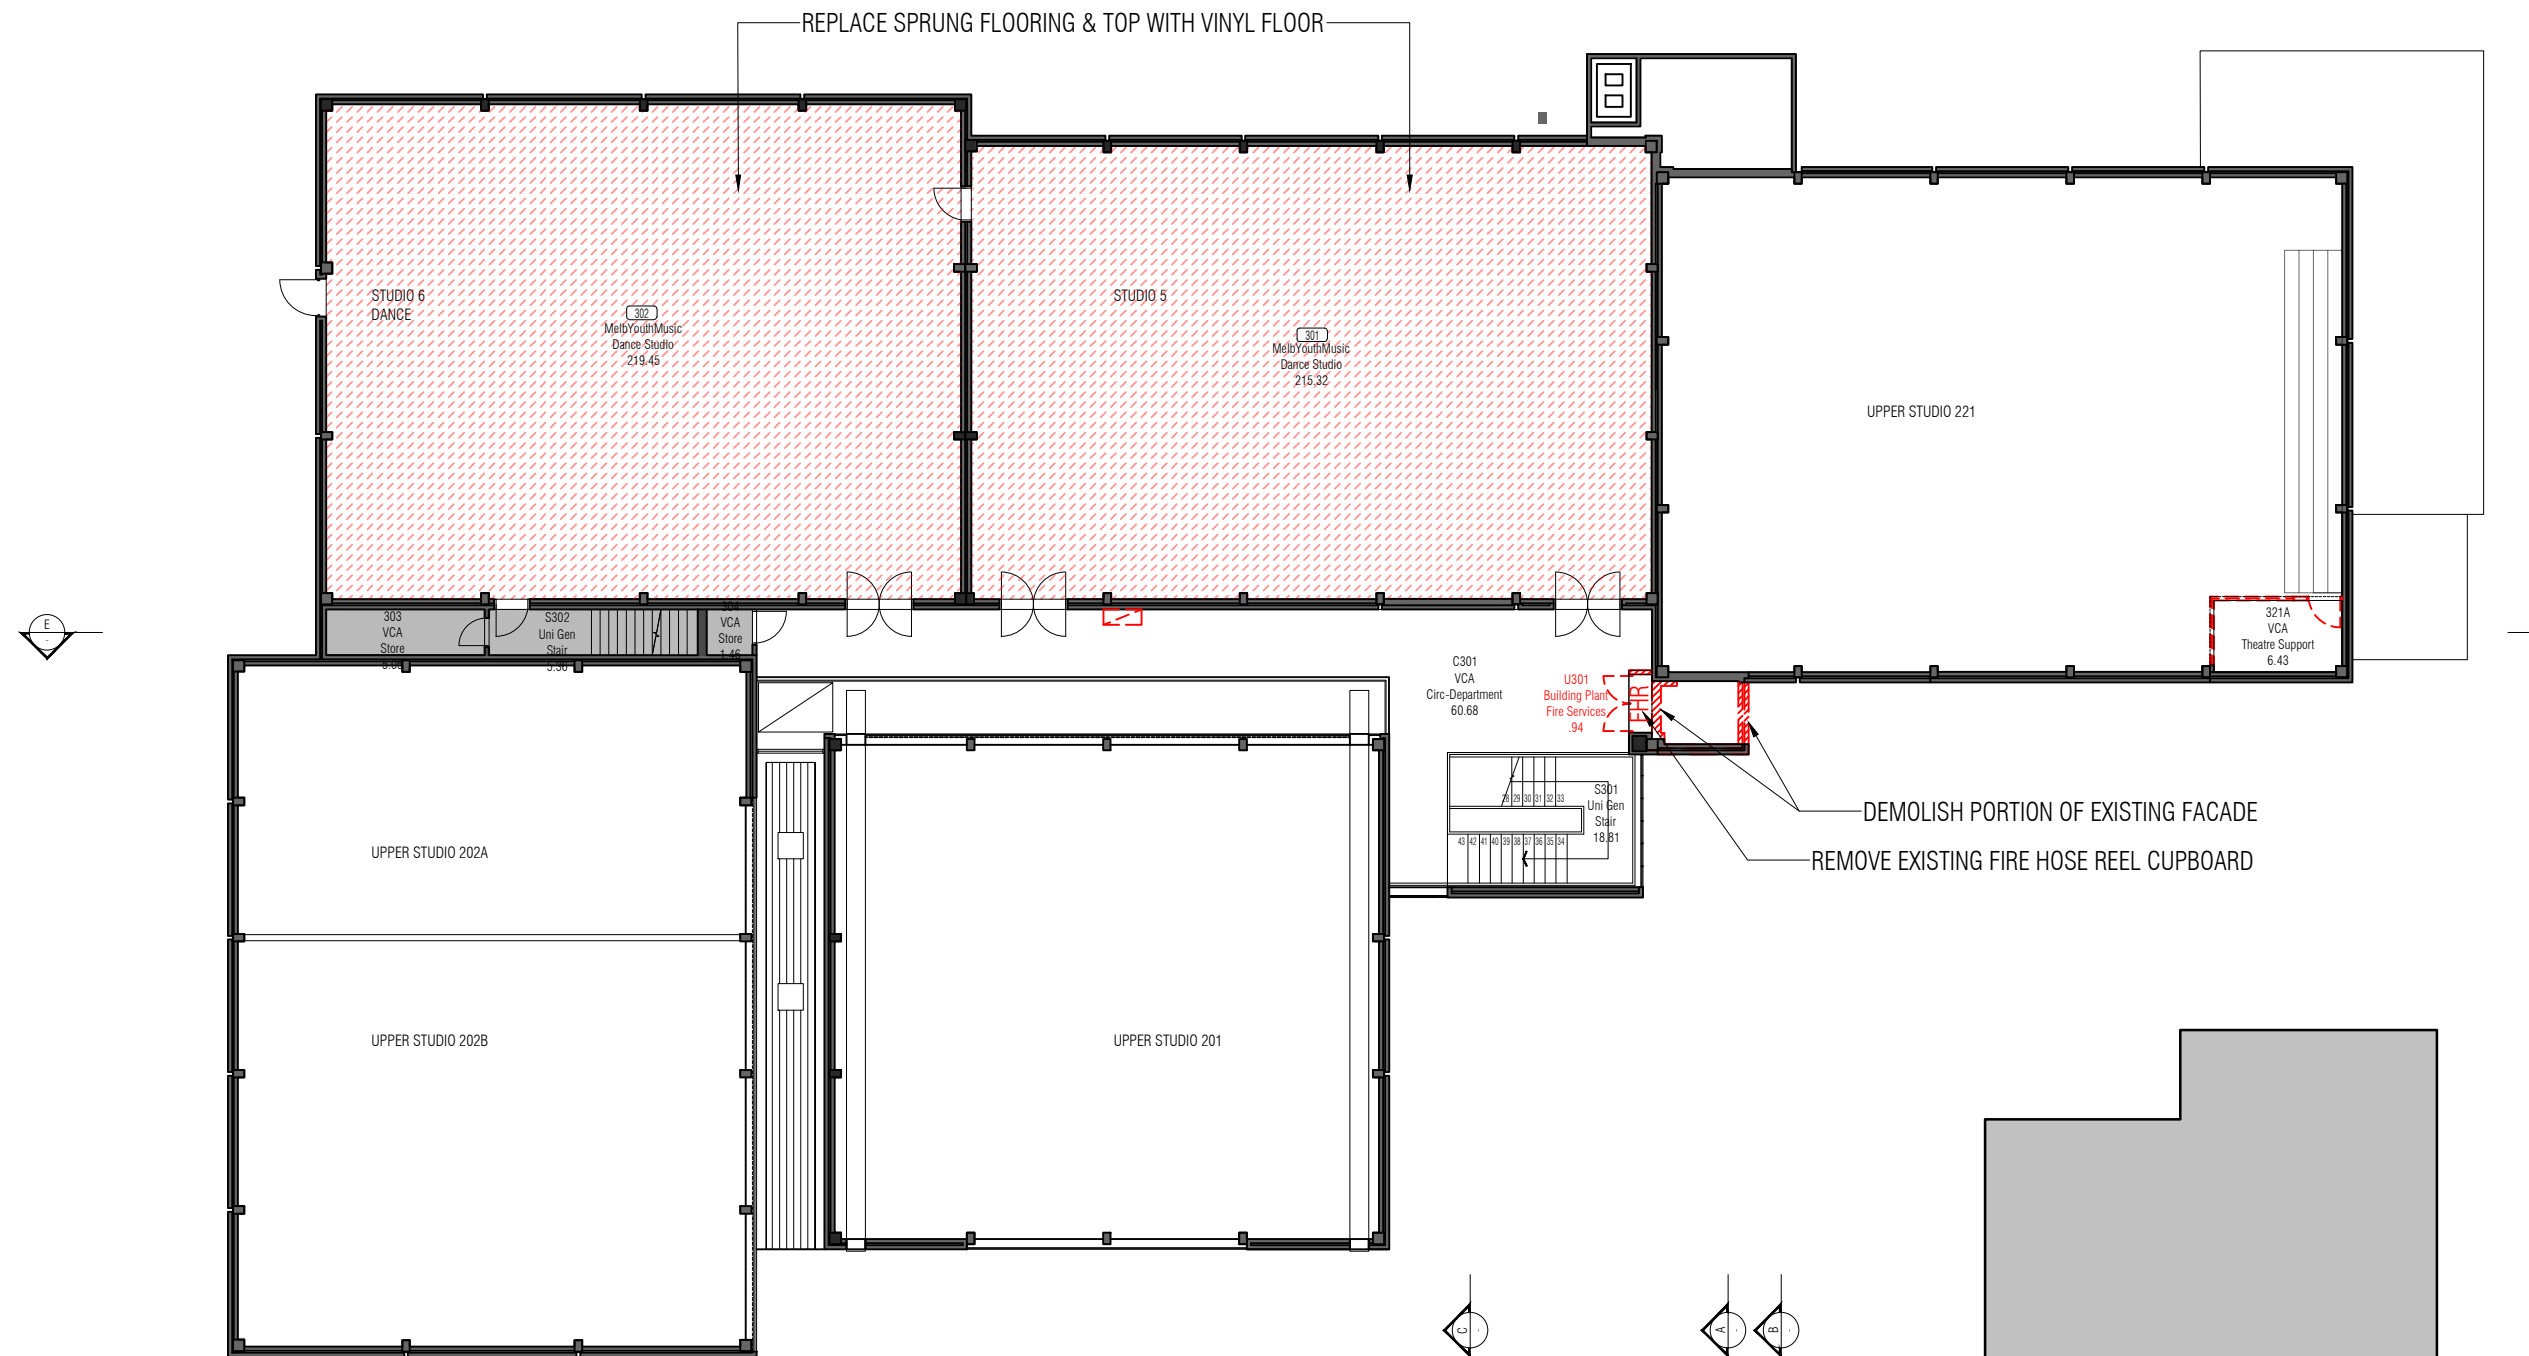


1 EXISTING PLAN - LEVEL 3
1:200@A3

- - - DEMOLITION
- FLOOR FINISHES TO BE DEMOLISHED
- OUT OF SCOPE

ALL DIMENSIONS AND LEVELS TO BE VERIFIED ON SITE BY THE BUILDER BEFORE THE COMMENCEMENT OF ANY WORK. ANY DISCREPANCIES MUST BE REPORTED TO THE ARCHITECT IMMEDIATELY. DO NOT SCALE DRAWINGS. FIGURED DIMENSIONS HAVE PREFERENCE OVER DIMENSIONS SCALED FROM THE DRAWINGS. THESE DRAWINGS TO BE READ IN CONJUNCTION WITH THE SPECIFICATIONS AND OTHER ASSOCIATED DOCUMENTS. REFER TO ENGINEERING SERVICES DRAWINGS FOR CONFIRMATION OF LOCATIONS AND HEIGHT OF FITTINGS, AIR DIFFUSERS, GRILLES, SPRINKLERS, SMOKE DETECTORS, AND ALL OTHER CEILING MOUNTED OR RECESSED SERVICE OUTLETS AND FITTINGS AND ADDITIONAL SET OUT OF CEILING SUPPORT MEMBERS. MAKE ALL PENETRATIONS, CUT OUTS AND TRIM TO SUIT ALL RELEVANT SERVICE OUTLETS AND FITTINGS. ANY DISCREPANCIES BETWEEN THE ARCHITECTURAL AND SERVICES DOCUMENTS ARE TO BE REPORTED TO THE ARCHITECT FOR CLARIFICATION. IN THE EVENT OF DISCREPANCIES, THE CONTRACTOR MUST ALLOW FOR THE HIGHER COST ALTERNATIVE IN THE SCOPE OF WORKS. NOM INDICATES A NOMINAL DIMENSION TO BE CHECKED ON SITE.

REV	DESCRIPTION	DRAWN	DATE
1	FOR COORDINATION	-	08.02.2024
2	FOR COORDINATION	-	29.02.2024
3	FOR COORDINATION	-	06.03.2024
4	FOR HERITAGE PERMIT	-	10.05.2024

CLIENT



VICTORIAN COLLEGE OF THE ARTS
The University of Melbourne

SERVICES ENGINEERING
Caleb Engineers
206 / 7 Jelfcott St,
West Melbourne, VIC 3003.
Ph. 9020 9347

BUILDING SURVEYOR
Wilmore Nelson McDermott
Suite 105/80 Monash Dr,
Dandenong South, VIC 3175.
Ph. 1300 799 543

STRUCTURAL ENGINEERING
Engineering Folk
0413 516 870

COST CONSULTANT


H2o architects Pty Ltd
29 Northumberland Street
Collingwood
Victoria 3066 Australia
T 61 3 9417 0900
F 61 3 9417 0911
studio@h2oarchitects.com.au

PROJECT
**UNIVERSITY OF MELBOURNE
BLDG 864 - PERFORMING ARTS**

DRAWING TITLE
**EXISTING & DEMO PLAN
LEVEL 3**

DRAWN BY
H2o

PROJECT NUMBER
2356




SCALE
1:200 @ A3

PLOT DATE
10.05.2024

FOR HERITAGE PERMIT

DRAWING NUMBER
A0.12

REVISION
4

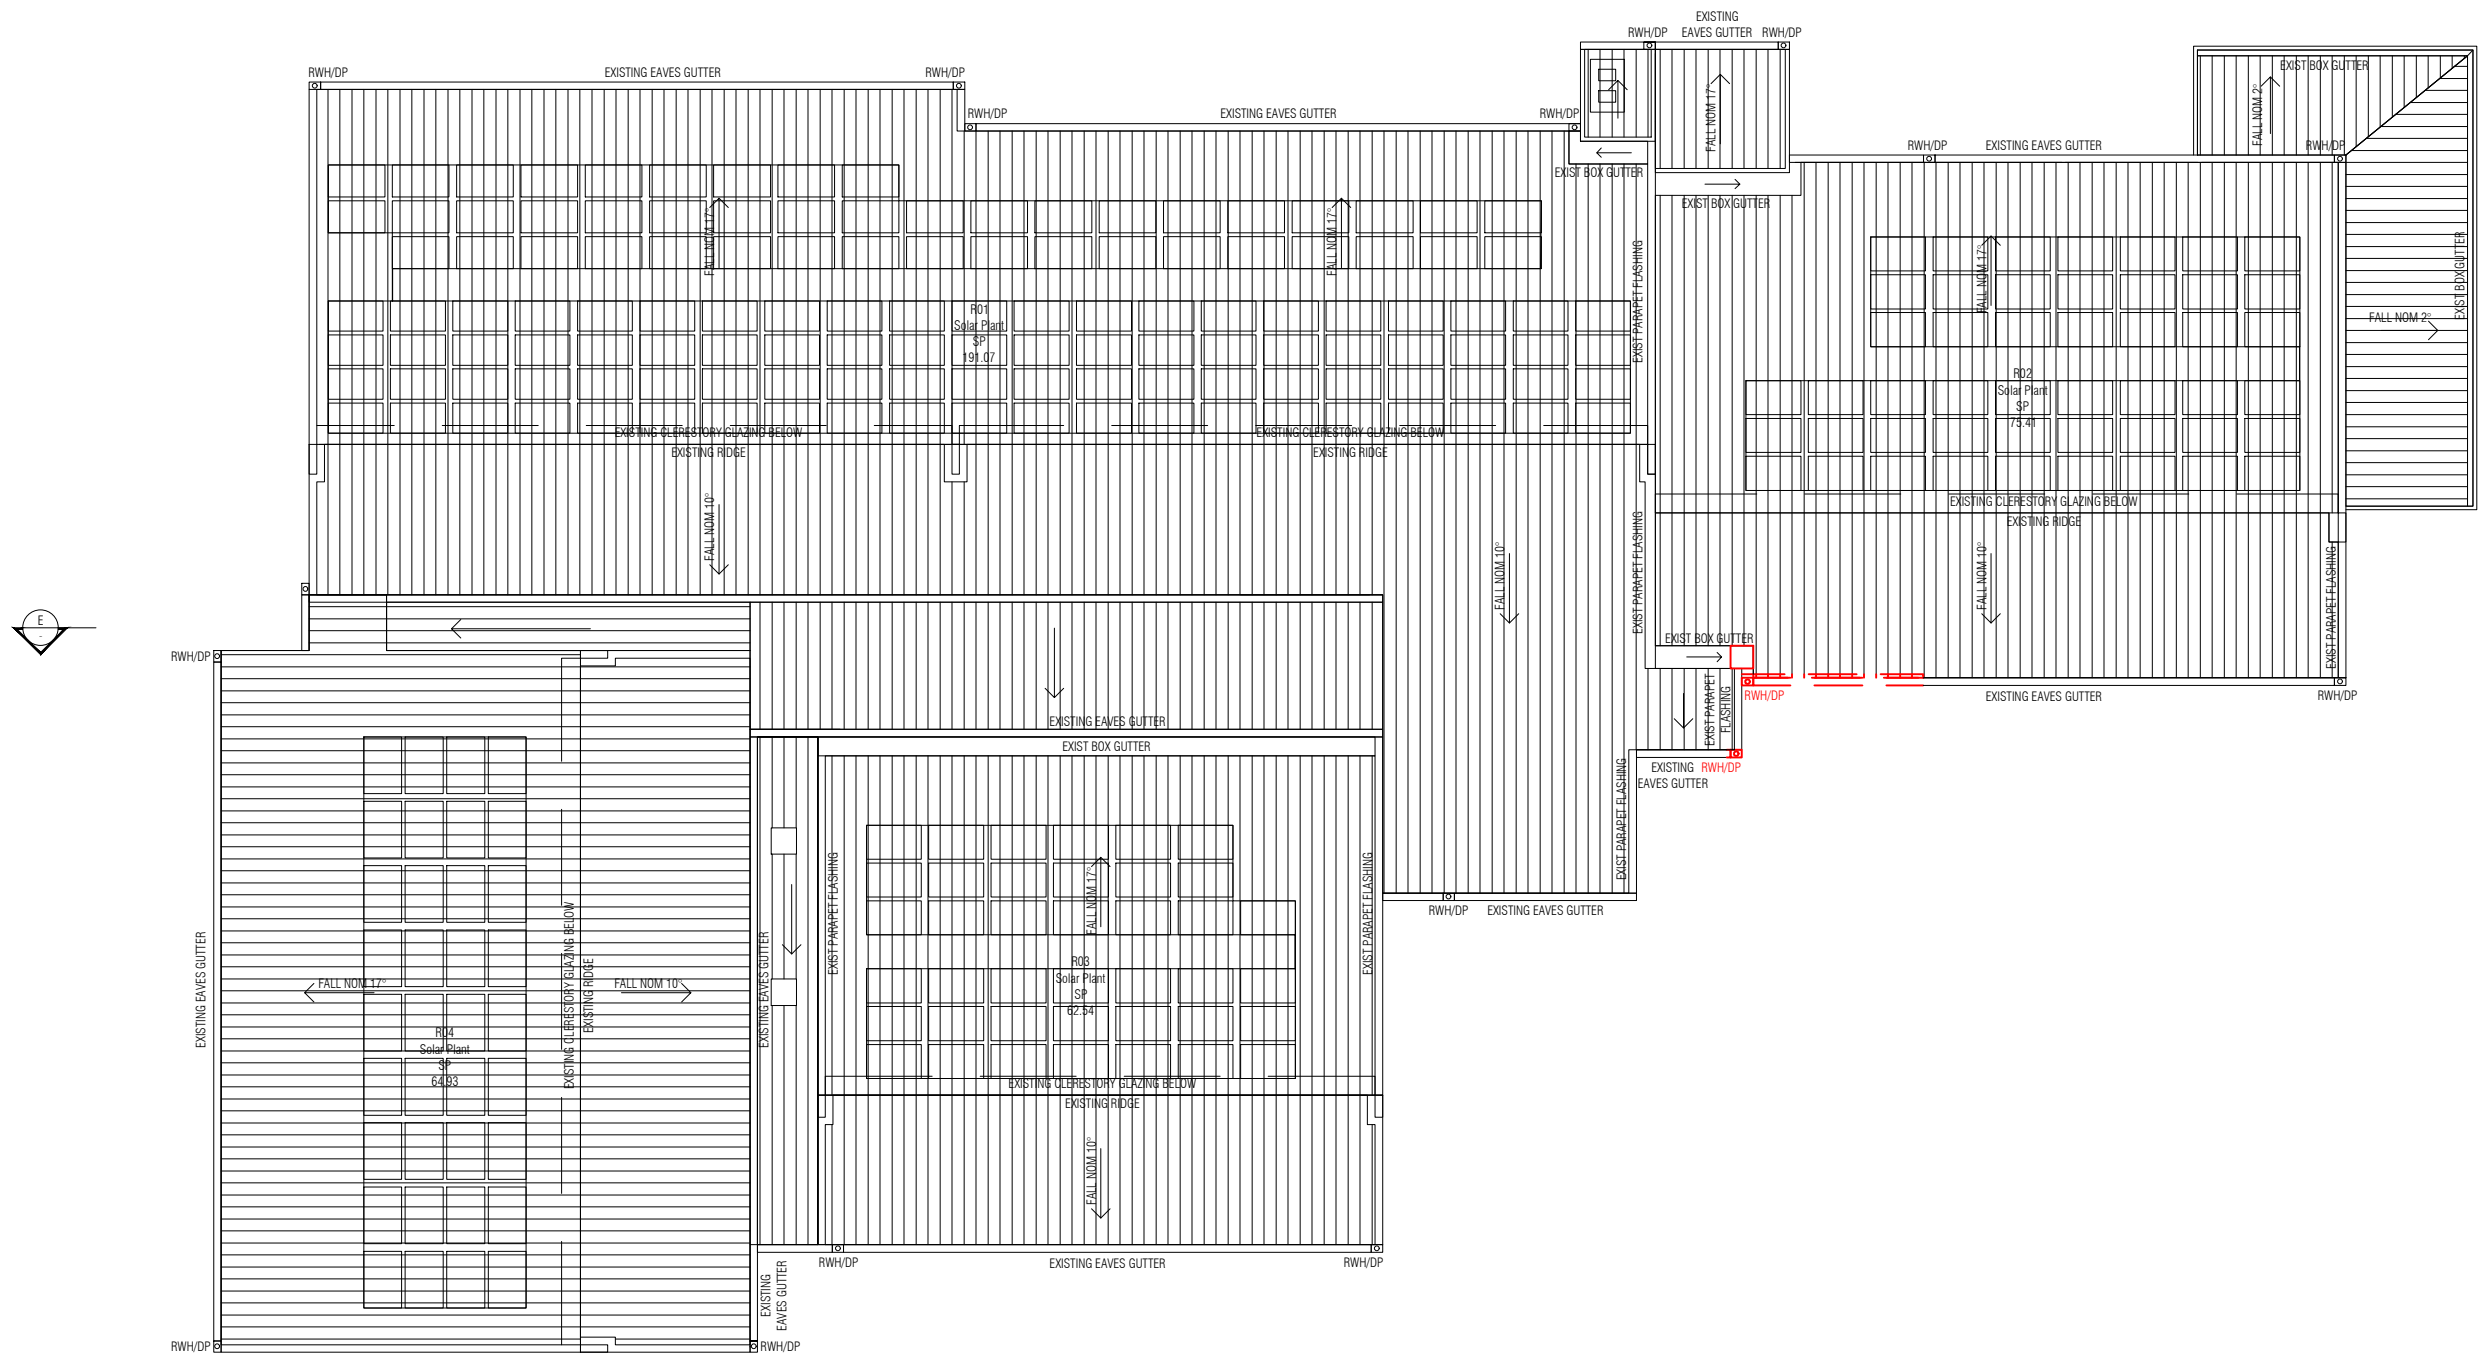

1 EXISTING PLAN - ROOF
1:200@A3

--- DEMOLITION
 ■ OUT OF SCOPE

ALL DIMENSIONS AND LEVELS TO BE VERIFIED ON SITE BY THE BUILDER BEFORE THE COMMENCEMENT OF ANY WORK. ANY DISCREPANCIES MUST BE REPORTED TO THE ARCHITECT IMMEDIATELY. DO NOT SCALE DRAWINGS. FIGURED DIMENSIONS HAVE PREFERENCE OVER DIMENSIONS SCALED FROM THE DRAWINGS. THESE DRAWINGS TO BE READ IN CONJUNCTION WITH THE SPECIFICATIONS AND OTHER ASSOCIATED DOCUMENTS. REFER TO ENGINEERING SERVICES DRAWINGS FOR CONFIRMATION OF LOCATIONS AND HEIGHT OF FITTINGS, AIR DIFFUSERS, GRILLES, SPRINKLERS, SMOKE DETECTORS, AND ALL OTHER CEILING MOUNTED OR RECESSED SERVICE OUTLETS AND FITTINGS AND ADDITIONAL SET OUT OF CEILING SUPPORT MEMBERS. MAKE ALL PENETRATIONS, CUT OUTS AND TRIM TO SUIT ALL RELEVANT SERVICE OUTLETS AND FITTINGS. ANY DISCREPANCIES BETWEEN THE ARCHITECTURAL AND SERVICES DOCUMENTS ARE TO BE REPORTED TO THE ARCHITECT FOR CLARIFICATION. IN THE EVENT OF DISCREPANCIES, THE CONTRACTOR MUST ALLOW FOR THE HIGHER COST ALTERNATIVE IN THE SCOPE OF WORKS. NOM INDICATES A NOMINAL DIMENSION TO BE CHECKED ON SITE.

REV	DESCRIPTION	DRAWN	DATE
1	FOR COORDINATION	-	19.04.2024
2	FOR HERITAGE PERMIT	-	10.05.2024

CLIENT



VICTORIAN COLLEGE OF THE ARTS
The University of Melbourne

SERVICES ENGINEERING
Caleb Engineers
206 / 7 Jelfcott St,
West Melbourne, VIC 3003.
Ph. 9020 9347

BUILDING SURVEYOR
Wilmore Nelson McDermott
Suite 105/80 Monash Dr,
Dandenong South, VIC 3175.
Ph. 1300 799 543

STRUCTURAL ENGINEERING
Engineering Folk
0413 516 870

COST CONSULTANT


H2o architects Pty Ltd
29 Northumberland Street
Collingwood
Victoria 3066 Australia
T 61 3 9417 0900
F 61 3 9417 0911
studio@h2oarchitects.com.au

PROJECT
**UNIVERSITY OF MELBOURNE
BLDG 864 - PERFORMING ARTS**

DRAWING TITLE
**EXISTING & DEMO PLAN
ROOF**

DRAWN BY
H2o

PROJECT NUMBER
2356




SCALE
1:200 @ A3

PLOT DATE
10.05.2024


FOR HERITAGE PERMIT

DRAWING NUMBER
A0.13

REVISION
2

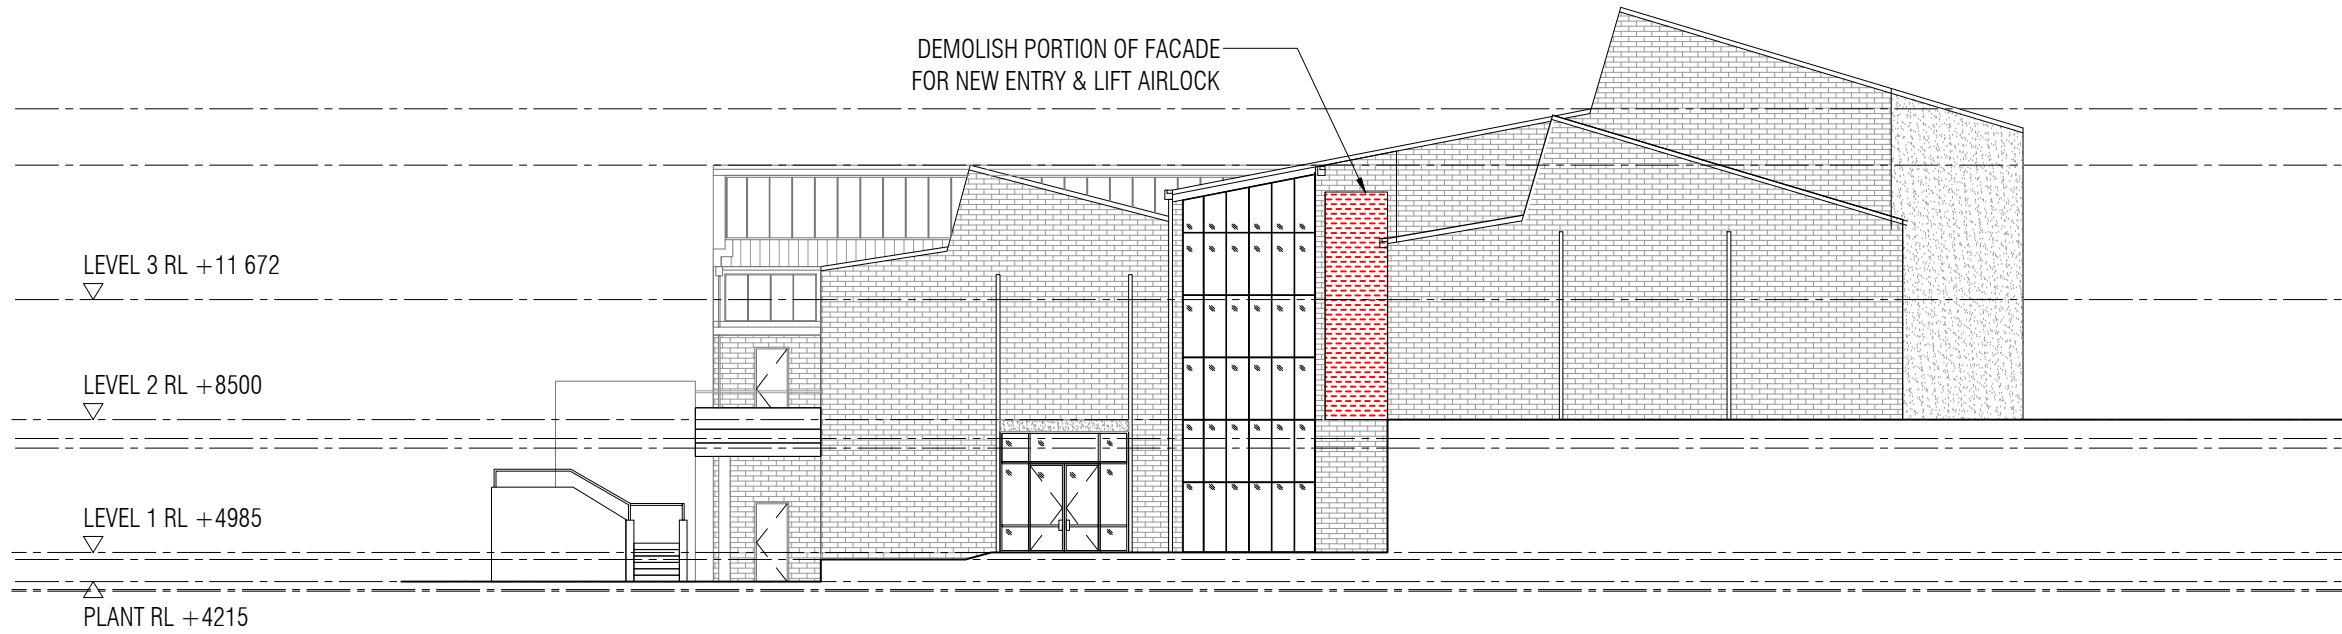

1 EXISTING EAST ELEVATION
1:200@A3

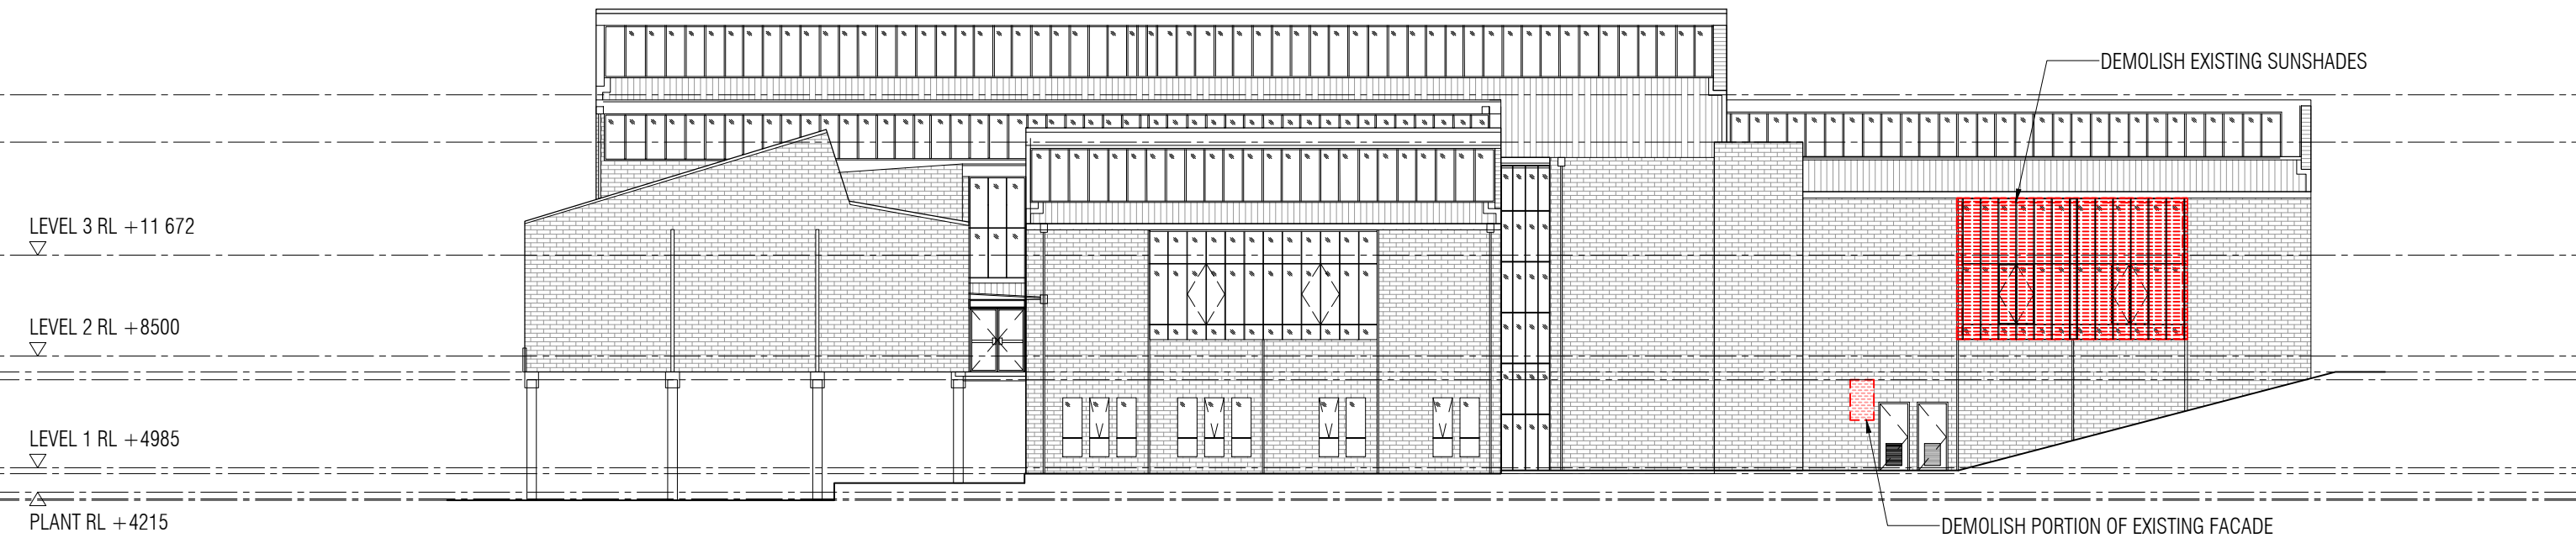

2 EXISTING SOUTH ELEVATION
1:200@A3

--- DEMOLITION
■ OUT OF SCOPE

ALL DIMENSIONS AND LEVELS TO BE VERIFIED ON SITE BY THE BUILDER BEFORE THE COMMENCEMENT OF ANY WORK. ANY DISCREPANCIES MUST BE REPORTED TO THE ARCHITECT IMMEDIATELY. DO NOT SCALE DRAWINGS. FIGURED DIMENSIONS HAVE PREFERENCE OVER DIMENSIONS SCALED FROM THE DRAWINGS. THESE DRAWINGS TO BE READ IN CONJUNCTION WITH THE SPECIFICATIONS AND OTHER ASSOCIATED DOCUMENTS. REFER TO ENGINEERING SERVICES DRAWINGS FOR CONFIRMATION OF LOCATIONS AND HEIGHT OF FITTINGS, AIR DIFFUSERS, GRILLES, SPRINKLERS, SMOKE DETECTORS, AND ALL OTHER CEILING MOUNTED OR RECESSED SERVICE OUTLETS AND FITTINGS AND ADDITIONAL SET OUT OF CEILING SUPPORT MEMBERS. MAKE ALL PENETRATIONS, CUT OUTS AND TRIM TO SUIT ALL RELEVANT SERVICE OUTLETS AND FITTINGS. ANY DISCREPANCIES BETWEEN THE ARCHITECTURAL AND SERVICES DOCUMENTS ARE TO BE REPORTED TO THE ARCHITECT FOR CLARIFICATION. IN THE EVENT OF DISCREPANCIES, THE CONTRACTOR MUST ALLOW FOR THE HIGHER COST ALTERNATIVE IN THE SCOPE OF WORKS. NOM INDICATES A NOMINAL DIMENSION TO BE CHECKED ON SITE.

REV	DESCRIPTION	DRAWN	DATE	CLIENT
1	FOR HERITAGE PERMIT		10.05.2024	



SERVICES ENGINEERING
Caleb Engineers
206 / 7 Jellicott St,
West Melbourne, VIC 3003.
Ph. 9020 9347

STRUCTURAL ENGINEERING
Engineering Folk
0413 516 870

BUILDING SURVEYOR
Wilmore Nelson McDermott
Suite 105/80 Monash Dr,
Dandenong South, VIC 3175.
Ph. 1300 799 543

COST CONSULTANT

H2o architects Pty Ltd
29 Northumberland Street
Collingwood
Victoria 3066 Australia
T 61 3 9417 0900
F 61 3 9417 0911
studio@h2oarchitects.com.au



PROJECT
**UNIVERSITY OF MELBOURNE
BLDG 864 - PERFORMING ARTS**

DRAWING TITLE
EXISTING & DEMO ELEVATIONS

DRAWN BY
H2o
PROJECT NUMBER
2356




SCALE
1:200 @ A3

PLOT DATE
10.05.2024

FOR HERITAGE PERMIT

DRAWING NUMBER
A0.50

REVISION
1

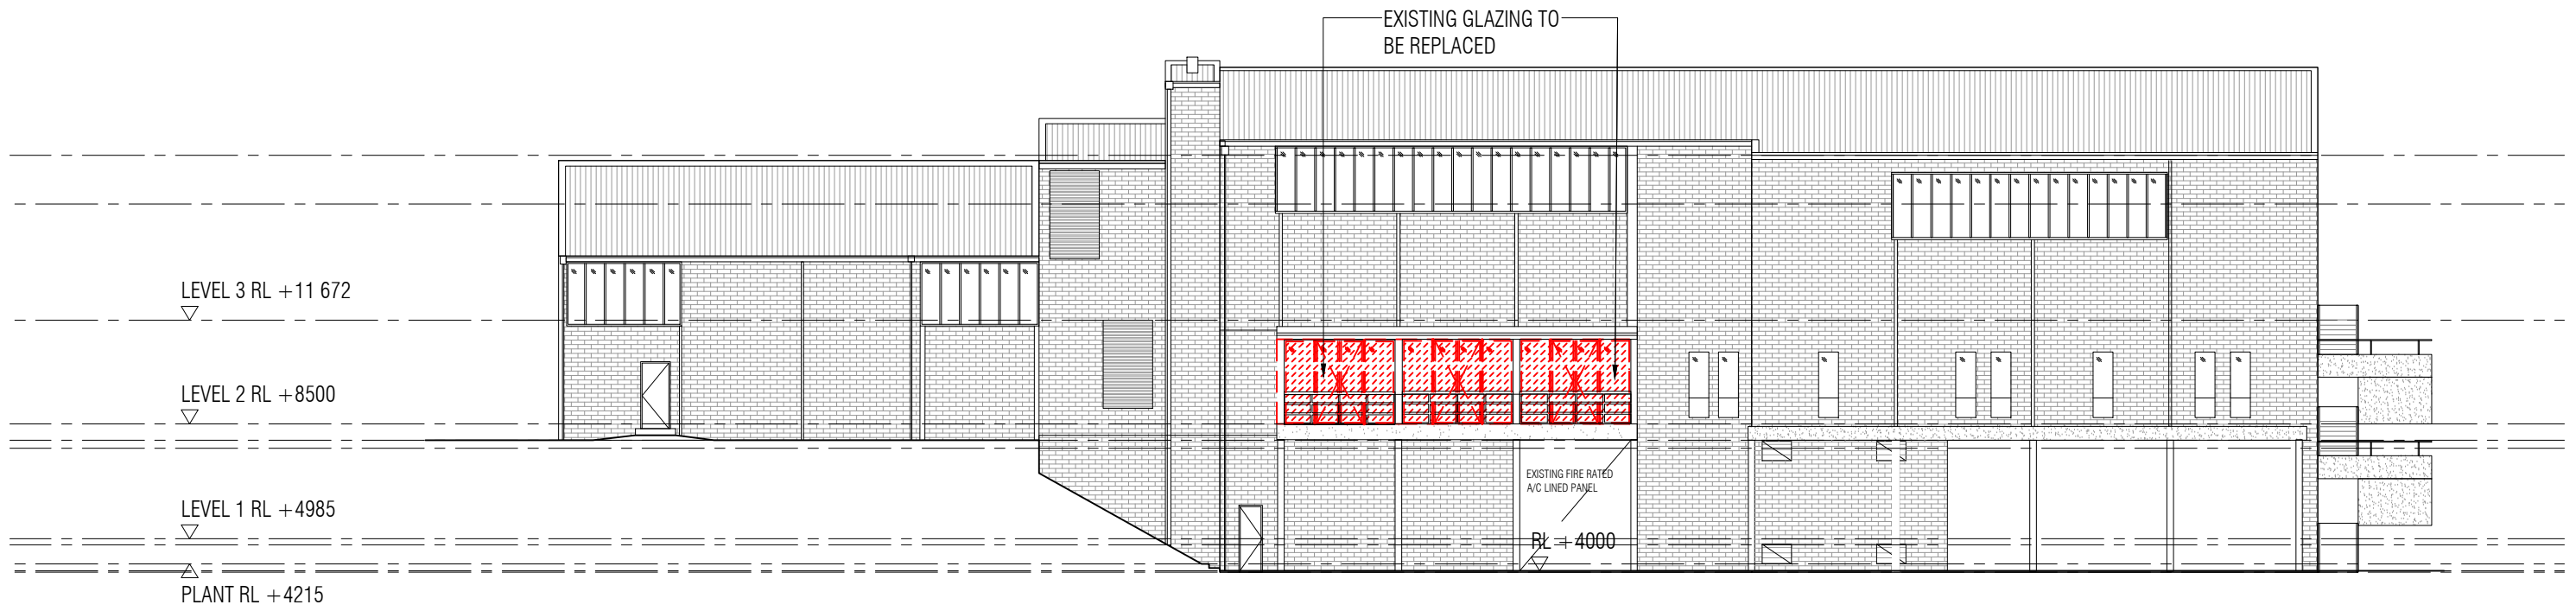

1 EXISTING NORTH ELEVATION
1:200@A3

--- DEMOLITION
■ OUT OF SCOPE

ALL DIMENSIONS AND LEVELS TO BE VERIFIED ON SITE BY THE BUILDER BEFORE THE COMMENCEMENT OF ANY WORK. ANY DISCREPANCIES MUST BE REPORTED TO THE ARCHITECT IMMEDIATELY. DO NOT SCALE DRAWINGS. FIGURED DIMENSIONS HAVE PREFERENCE OVER DIMENSIONS SCALED FROM THE DRAWINGS. THESE DRAWINGS TO BE READ IN CONJUNCTION WITH THE SPECIFICATIONS AND OTHER ASSOCIATED DOCUMENTS. REFER TO ENGINEERING SERVICES DRAWINGS FOR CONFIRMATION OF LOCATIONS AND HEIGHT OF FITTINGS, AIR DIFFUSERS, GRILLES, SPRINKLERS, SMOKE DETECTORS, AND ALL OTHER CEILING MOUNTED OR RECESSED SERVICE OUTLETS AND FITTINGS AND ADDITIONAL SET OUT OF CEILING SUPPORT MEMBERS. MAKE ALL PENETRATIONS, CUT OUTS AND TRIM TO SUIT ALL RELEVANT SERVICE OUTLETS AND FITTINGS. ANY DISCREPANCIES BETWEEN THE ARCHITECTURAL AND SERVICES DOCUMENTS ARE TO BE REPORTED TO THE ARCHITECT FOR CLARIFICATION. IN THE EVENT OF DISCREPANCIES, THE CONTRACTOR MUST ALLOW FOR THE HIGHER COST ALTERNATIVE IN THE SCOPE OF WORKS. NOM INDICATES A NOMINAL DIMENSION TO BE CHECKED ON SITE.

REV	DESCRIPTION	DRAWN	DATE
1	FOR HERITAGE PERMIT	-	10.05.2024

CLIENT



VICTORIAN COLLEGE OF THE ARTS
The University of Melbourne

SERVICES ENGINEERING
Caleb Engineers
206 / 7 Jellicott St,
West Melbourne, VIC 3003.
Ph. 9020 9347

BUILDING SURVEYOR
Wilmore Nelson McDermott
Suite 105/80 Monash Dr,
Dandenong South, VIC 3175.
Ph. 1300 799 543

STRUCTURAL ENGINEERING
Engineering Folk
0413 516 870

COST CONSULTANT


H2o architects Pty Ltd
29 Northumberland Street
Collingwood
Victoria 3066 Australia
T 61 3 9417 0900
F 61 3 9417 0911
studio@h2oarchitects.com.au

PROJECT
**UNIVERSITY OF MELBOURNE
BLDG 864 - PERFORMING ARTS**

DRAWING TITLE
EXISTING & DEMO ELEVATIONS

DRAWN BY
H2o

PROJECT NUMBER
2356




SCALE
1:200 @ A3

PLOT DATE
10.05.2024


FOR HERITAGE PERMIT

DRAWING NUMBER
A0.51


REVISION
1

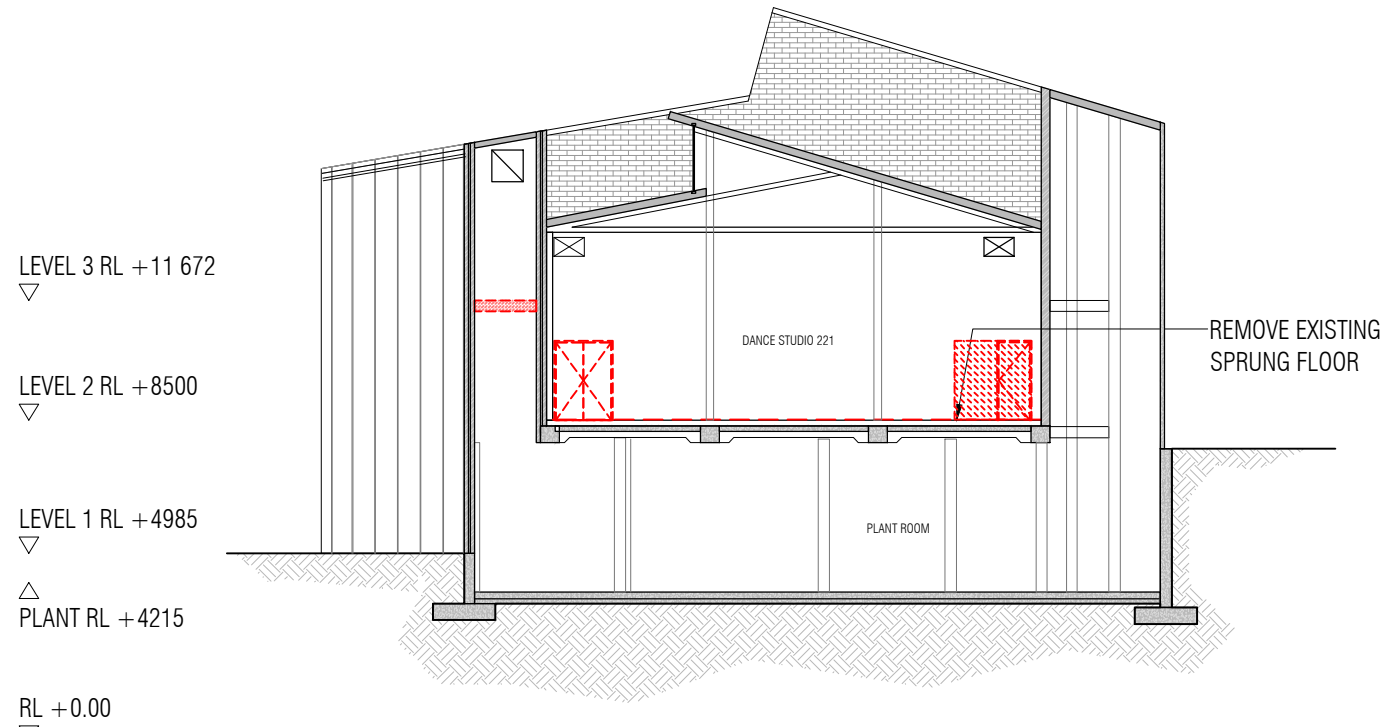

A EXISTING SECTION A
1:200@A3

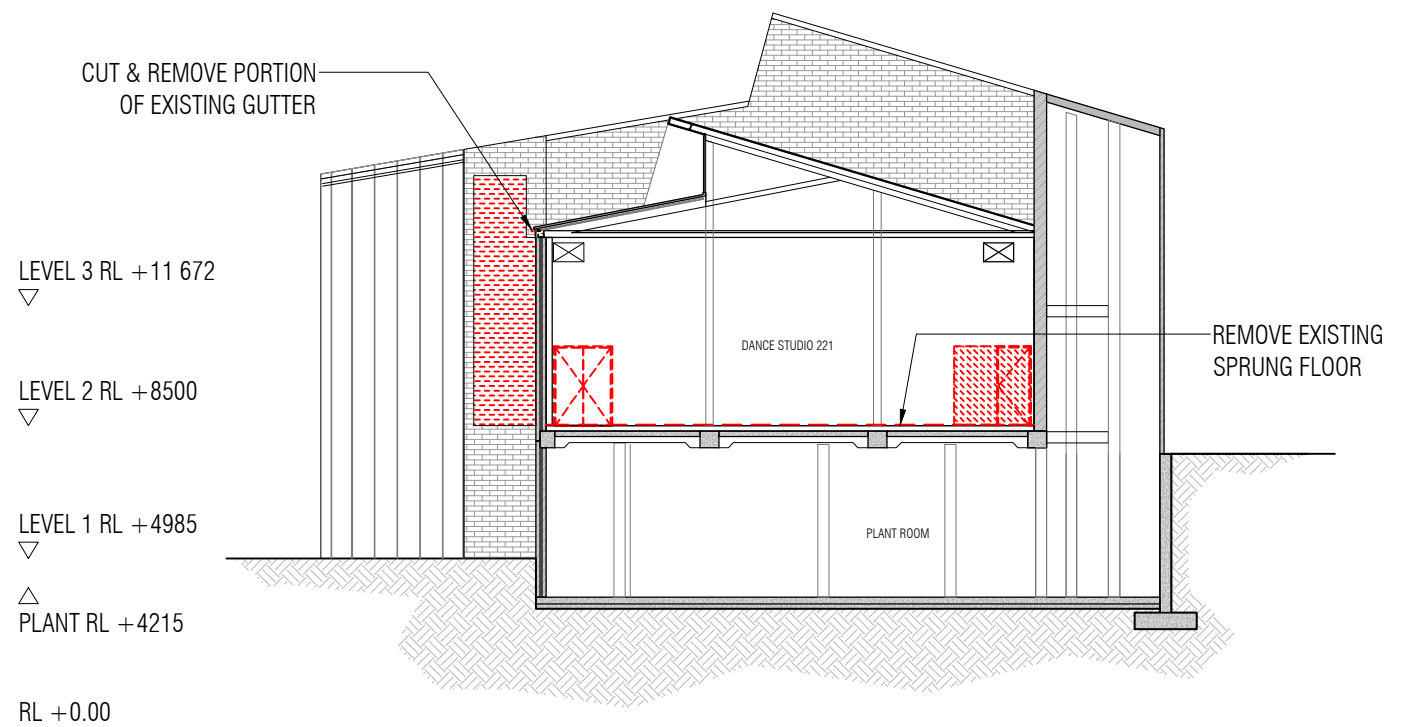

B EXISTING SECTION B
1:200@A3

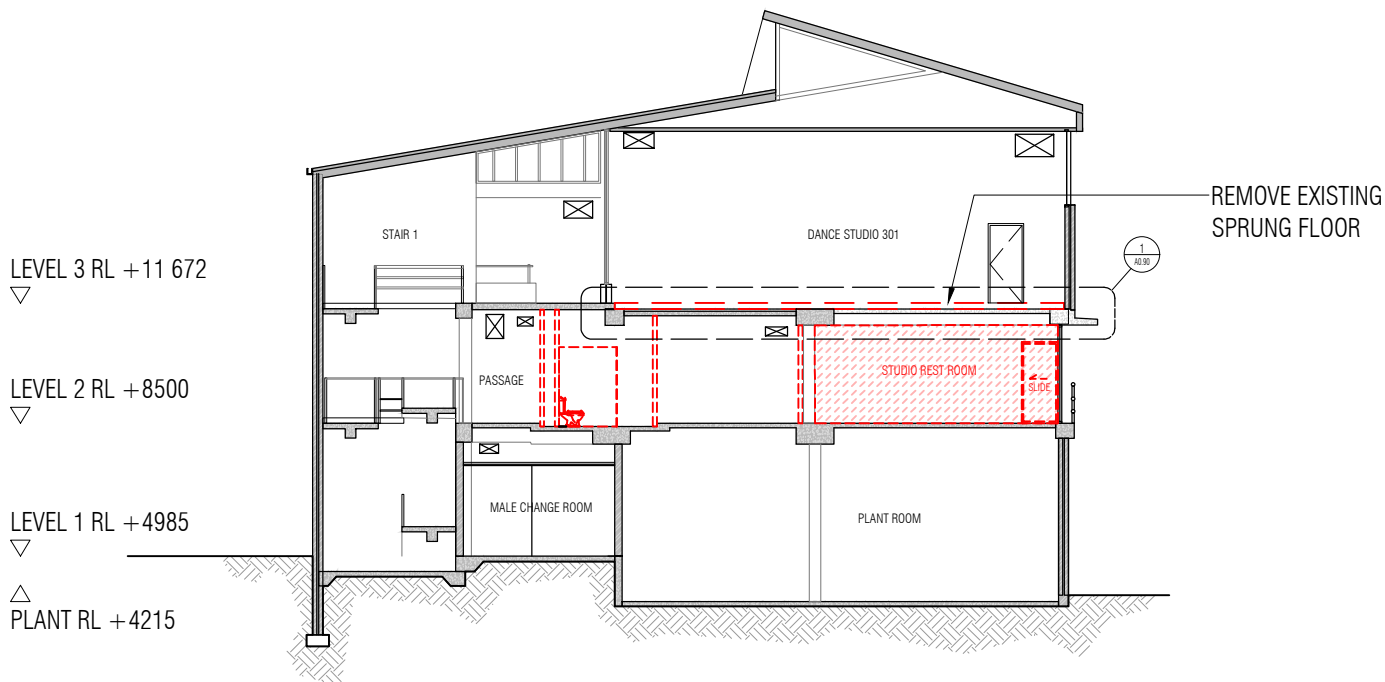

C EXISTING SECTION C
1:200@A3

----- DEMOLITION
 ■ OUT OF SCOPE

ALL DIMENSIONS AND LEVELS TO BE VERIFIED ON SITE BY THE BUILDER BEFORE THE COMMENCEMENT OF ANY WORK. ANY DISCREPANCIES MUST BE REPORTED TO THE ARCHITECT IMMEDIATELY. DO NOT SCALE DRAWINGS. FIGURED DIMENSIONS HAVE PREFERENCE OVER DIMENSIONS SCALED FROM THE DRAWINGS. THESE DRAWINGS TO BE READ IN CONJUNCTION WITH THE SPECIFICATIONS AND OTHER ASSOCIATED DOCUMENTS. REFER TO ENGINEERING SERVICES DRAWINGS FOR CONFIRMATION OF LOCATIONS AND HEIGHT OF FITTINGS, AIR DIFFUSERS, GRILLES, SPRINKLERS, SMOKE DETECTORS, AND ALL OTHER CEILING MOUNTED OR RECESSED SERVICE OUTLETS AND FITTINGS AND ADDITIONAL SET OUT OF CEILING SUPPORT MEMBERS. MAKE ALL PENETRATIONS, CUT OUTS AND TRIM TO SUIT ALL RELEVANT SERVICE OUTLETS AND FITTINGS. ANY DISCREPANCIES BETWEEN THE ARCHITECTURAL AND SERVICES DOCUMENTS ARE TO BE REPORTED TO THE ARCHITECT FOR CLARIFICATION. IN THE EVENT OF DISCREPANCIES, THE CONTRACTOR MUST ALLOW FOR THE HIGHER COST ALTERNATIVE IN THE SCOPE OF WORKS. NOM INDICATES A NOMINAL DIMENSION TO BE CHECKED ON SITE.

REV	DESCRIPTION	DRAWN	DATE	CLIENT
1	FOR HERITAGE PERMIT		10.05.2024	



SERVICES ENGINEERING
 Caleb Engineers
 206 / 7 Jelfcott St,
 West Melbourne, VIC 3003.
 Ph. 9020 9347

BUILDING SURVEYOR
 Wilmore Nelson McDermott
 Suite 105/80 Monash Dr,
 Dandenong South, VIC 3175.
 Ph. 1300 799 543

STRUCTURAL ENGINEERING
 Engineering Folk
 0413 516 870

COST CONSULTANT

H2o architects Pty Ltd
 29 Northumberland Street
 Collingwood
 Victoria 3066 Australia
 T 61 3 9417 0900
 F 61 3 9417 0911
 studio@h2oarchitects.com.au

PROJECT
**UNIVERSITY OF MELBOURNE
 BLDG 864 - PERFORMING ARTS**

DRAWING TITLE
EXISTING & DEMO SECTIONS

DRAWN BY
H2o

PROJECT NUMBER
2356

SCALE
1:200 @ A3

PLOT DATE
10.05.2024

FOR HERITAGE PERMIT

DRAWING NUMBER
A0.60


REVISION
1

LEVEL 3 RL +11 672

LEVEL 2 RL +8500

LEVEL 1 RL +4985

PLANT RL +4215

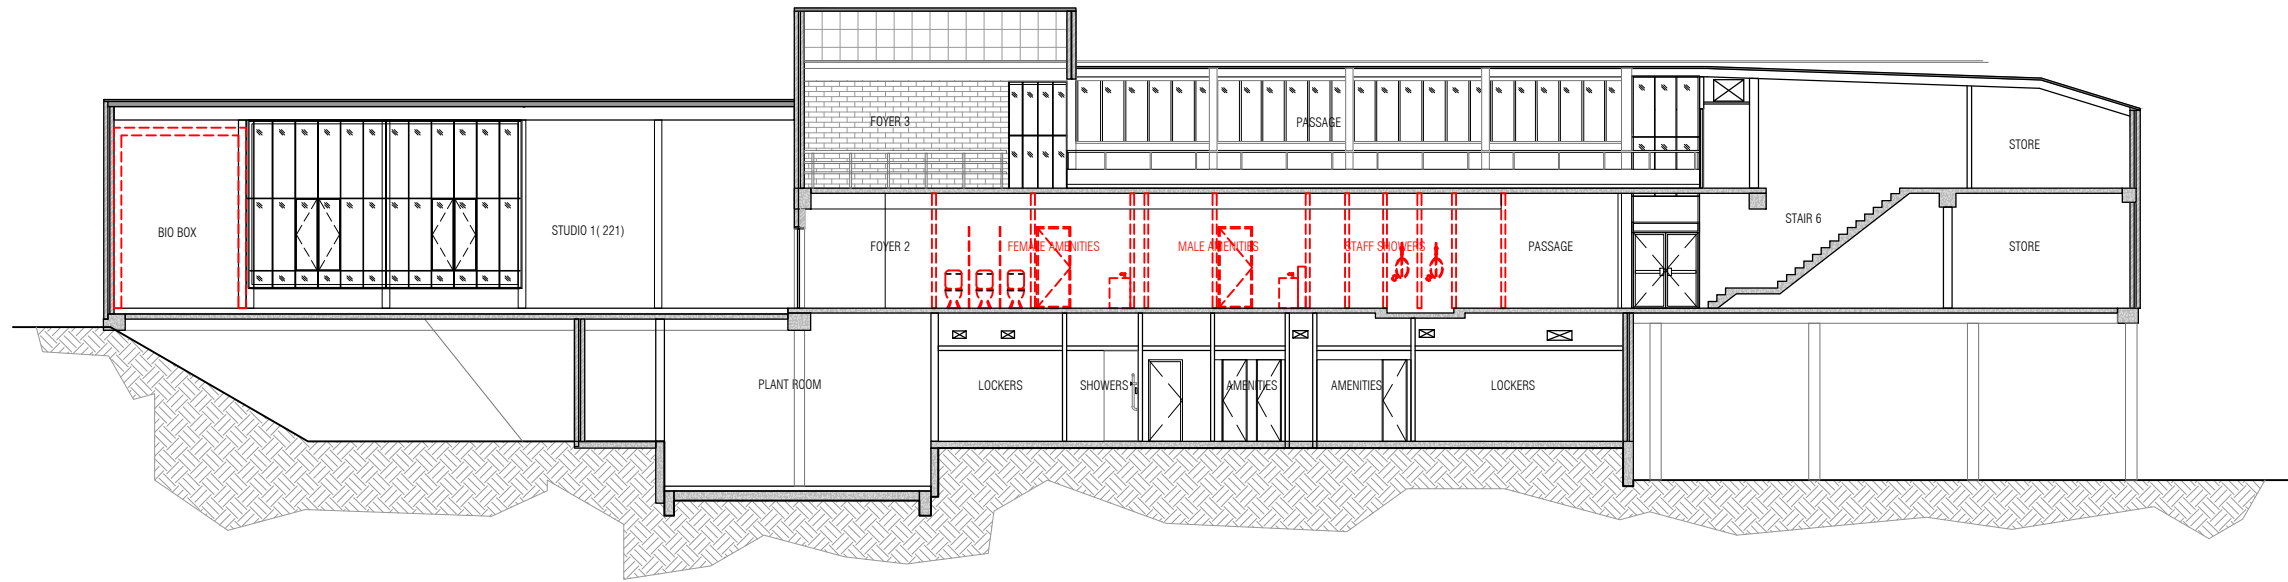

A EXISTING SECTION E
1:200@A3

----- DEMOLITION
 ■ OUT OF SCOPE

ALL DIMENSIONS AND LEVELS TO BE VERIFIED ON SITE BY THE BUILDER BEFORE THE COMMENCEMENT OF ANY WORK. ANY DISCREPANCIES MUST BE REPORTED TO THE ARCHITECT IMMEDIATELY. DO NOT SCALE DRAWINGS. FIGURED DIMENSIONS HAVE PREFERENCE OVER DIMENSIONS SCALED FROM THE DRAWINGS. THESE DRAWINGS TO BE READ IN CONJUNCTION WITH THE SPECIFICATIONS AND OTHER ASSOCIATED DOCUMENTS. REFER TO ENGINEERING SERVICES DRAWINGS FOR CONFIRMATION OF LOCATIONS AND HEIGHT OF FITTINGS, AIR DIFFUSERS, GRILLES, SPRINKLERS, SMOKE DETECTORS, AND ALL OTHER CEILING MOUNTED OR RECESSED SERVICE OUTLETS AND FITTINGS AND ADDITIONAL SET OUT OF CEILING SUPPORT MEMBERS. MAKE ALL PENETRATIONS, CUT OUTS AND TRIM TO SUIT ALL RELEVANT SERVICE OUTLETS AND FITTINGS. ANY DISCREPANCIES BETWEEN THE ARCHITECTURAL AND SERVICES DOCUMENTS ARE TO BE REPORTED TO THE ARCHITECT FOR CLARIFICATION. IN THE EVENT OF DISCREPANCIES, THE CONTRACTOR MUST ALLOW FOR THE HIGHER COST ALTERNATIVE IN THE SCOPE OF WORKS. NOM INDICATES A NOMINAL DIMENSION TO BE CHECKED ON SITE.

REV	DESCRIPTION	DRAWN	DATE	CLIENT
1	FOR HERITAGE PERMIT	-	10.05.2024	



SERVICES ENGINEERING
 Caleb Engineers
 206 / 7 Jellicott St,
 West Melbourne, VIC 3003.
 Ph. 9020 9347

BUILDING SURVEYOR
 Wilmore Nelson McDermott
 Suite 105/80 Monash Dr,
 Dandenong South, VIC 3175.
 Ph. 1300 799 543

STRUCTURAL ENGINEERING
 Engineering Folk
 0413 516 870

COST CONSULTANT

H2o architects Pty Ltd
 29 Northumberland Street
 Collingwood
 Victoria 3066 Australia
 T 61 3 9417 0900
 F 61 3 9417 0911
 studio@h2oarchitects.com.au

PROJECT
UNIVERSITY OF MELBOURNE
BLDG 864 - PERFORMING ARTS

DRAWING TITLE
EXISTING & DEMO SECTIONS

DRAWN BY
H2o

PROJECT NUMBER
2356


SCALE
1:200 @ A3

PLOT DATE
10.05.2024

FOR HERITAGE PERMIT

DRAWING NUMBER
A0.61

REVISION
1

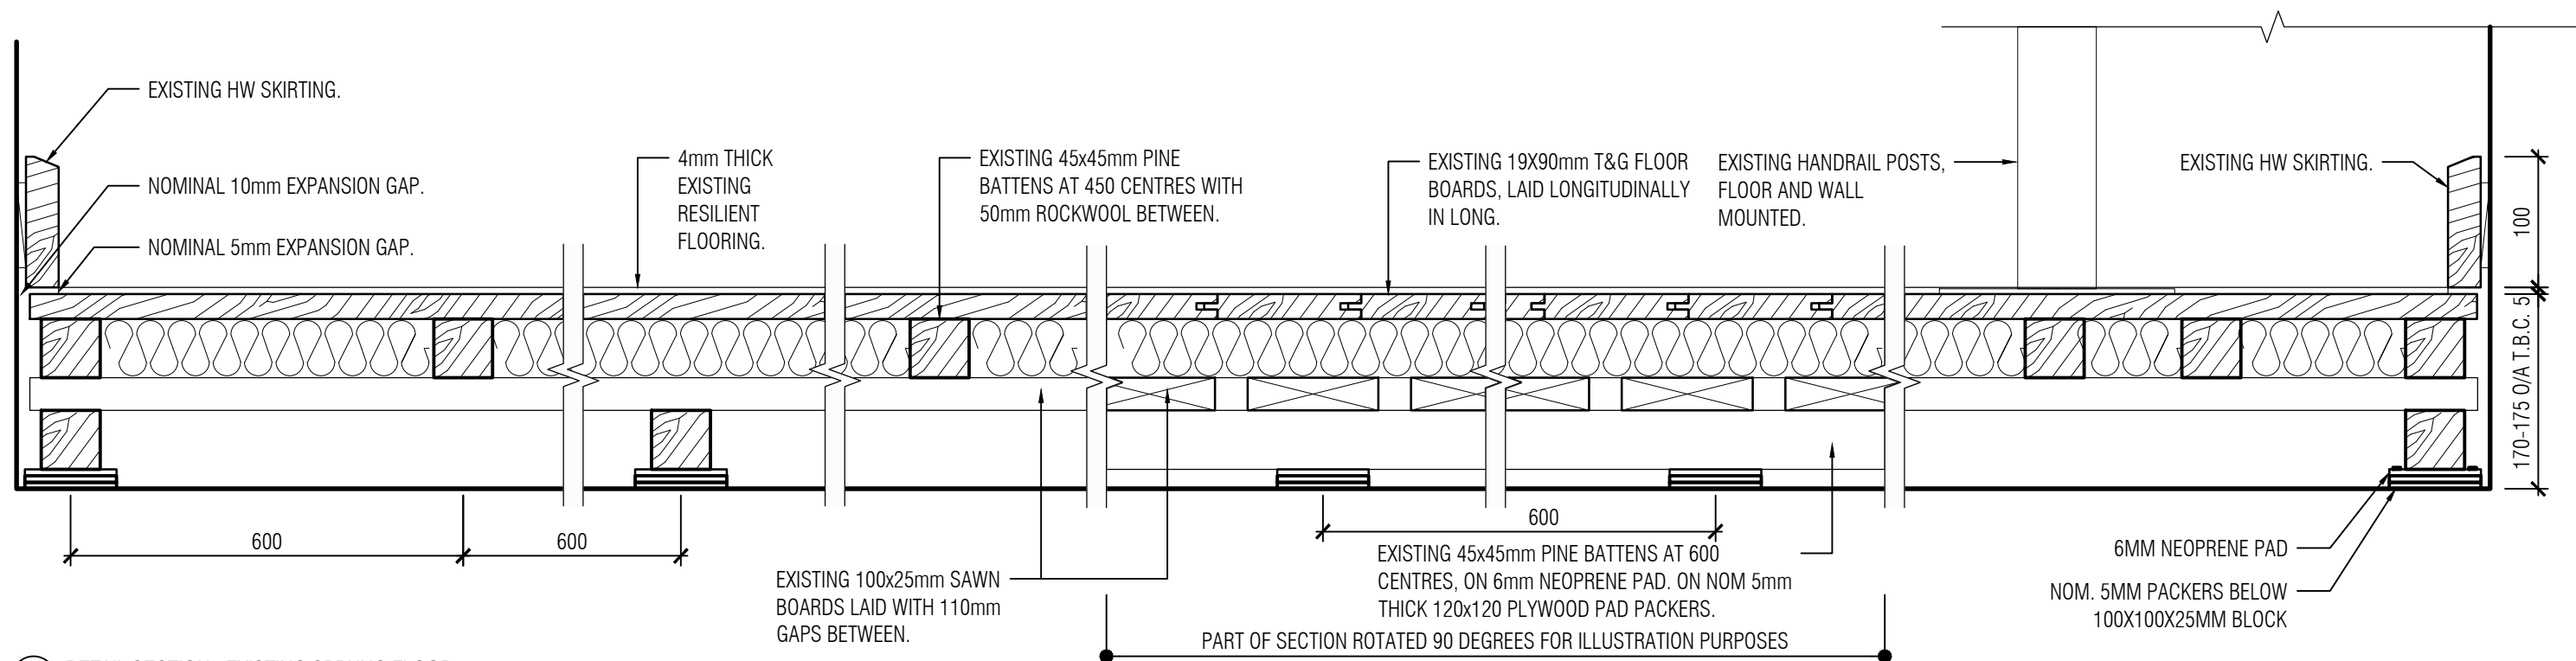

1 DETAIL SECTION - EXISTING SPRUNG FLOOR
1:5@A3

ALL DIMENSIONS AND LEVELS TO BE VERIFIED ON SITE BY THE BUILDER BEFORE THE COMMENCEMENT OF ANY WORK. ANY DISCREPANCIES MUST BE REPORTED TO THE ARCHITECT IMMEDIATELY. DO NOT SCALE DRAWINGS. FIGURED DIMENSIONS HAVE PREFERENCE OVER DIMENSIONS SCALED FROM THE DRAWINGS. THESE DRAWINGS TO BE READ IN CONJUNCTION WITH THE SPECIFICATIONS AND OTHER ASSOCIATED DOCUMENTS. REFER TO ENGINEERING SERVICES DRAWINGS FOR CONFIRMATION OF LOCATIONS AND HEIGHT OF FITTINGS, AIR DIFFUSERS, GRILLES, SPRINKLERS, SMOKE DETECTORS, AND ALL OTHER CEILING MOUNTED OR RECESSED SERVICE OUTLETS AND FITTINGS AND ADDITIONAL SET OUT OF CEILING SUPPORT MEMBERS. MAKE ALL PENETRATIONS, CUT OUTS AND TRIM TO SUIT ALL RELEVANT SERVICE OUTLETS AND FITTINGS. ANY DISCREPANCIES BETWEEN THE ARCHITECTURAL AND SERVICES DOCUMENTS ARE TO BE REPORTED TO THE ARCHITECT FOR CLARIFICATION. IN THE EVENT OF DISCREPANCIES, THE CONTRACTOR MUST ALLOW FOR THE HIGHER COST ALTERNATIVE IN THE SCOPE OF WORKS. NOM INDICATES A NOMINAL DIMENSION TO BE CHECKED ON SITE.

REV	DESCRIPTION	DRAWN	DATE	CLIENT
1	FOR HERITAGE PERMIT		10.05.2024	


VICTORIAN COLLEGE OF THE ARTS
 The University of Melbourne

SERVICES ENGINEERING
 Caleb Engineers
 206 / 7 Jelfcott St,
 West Melbourne, VIC 3003.
 Ph. 9020 9347

BUILDING SURVEYOR
 Wilmore Nelson McDermott
 Suite 105/80 Monash Dr,
 Dandenong South, VIC 3175.
 Ph. 1300 799 543

STRUCTURAL ENGINEERING
 Engineering Folk
 0413 516 870


COST CONSULTANT


H2o architects Pty Ltd
 29 Northumberland Street
 Collingwood
 Victoria 3066 Australia
 T 61 3 9417 0900
 F 61 3 9417 0911
 studio@h2oarchitects.com.au

H2o

PROJECT
 UNIVERSITY OF MELBOURNE
 BLDG 864 - PERFORMING ARTS

DRAWING TITLE
 EXISTING DETAILS
 SPRUNG FLOOR

DRAWN BY H2o	SCALE 1:5 @ A3	PLOT DATE 10.05.2024
PROJECT NUMBER 2356	FOR HERITAGE PERMIT	
	DRAWING NUMBER A0.90	REVISION 1

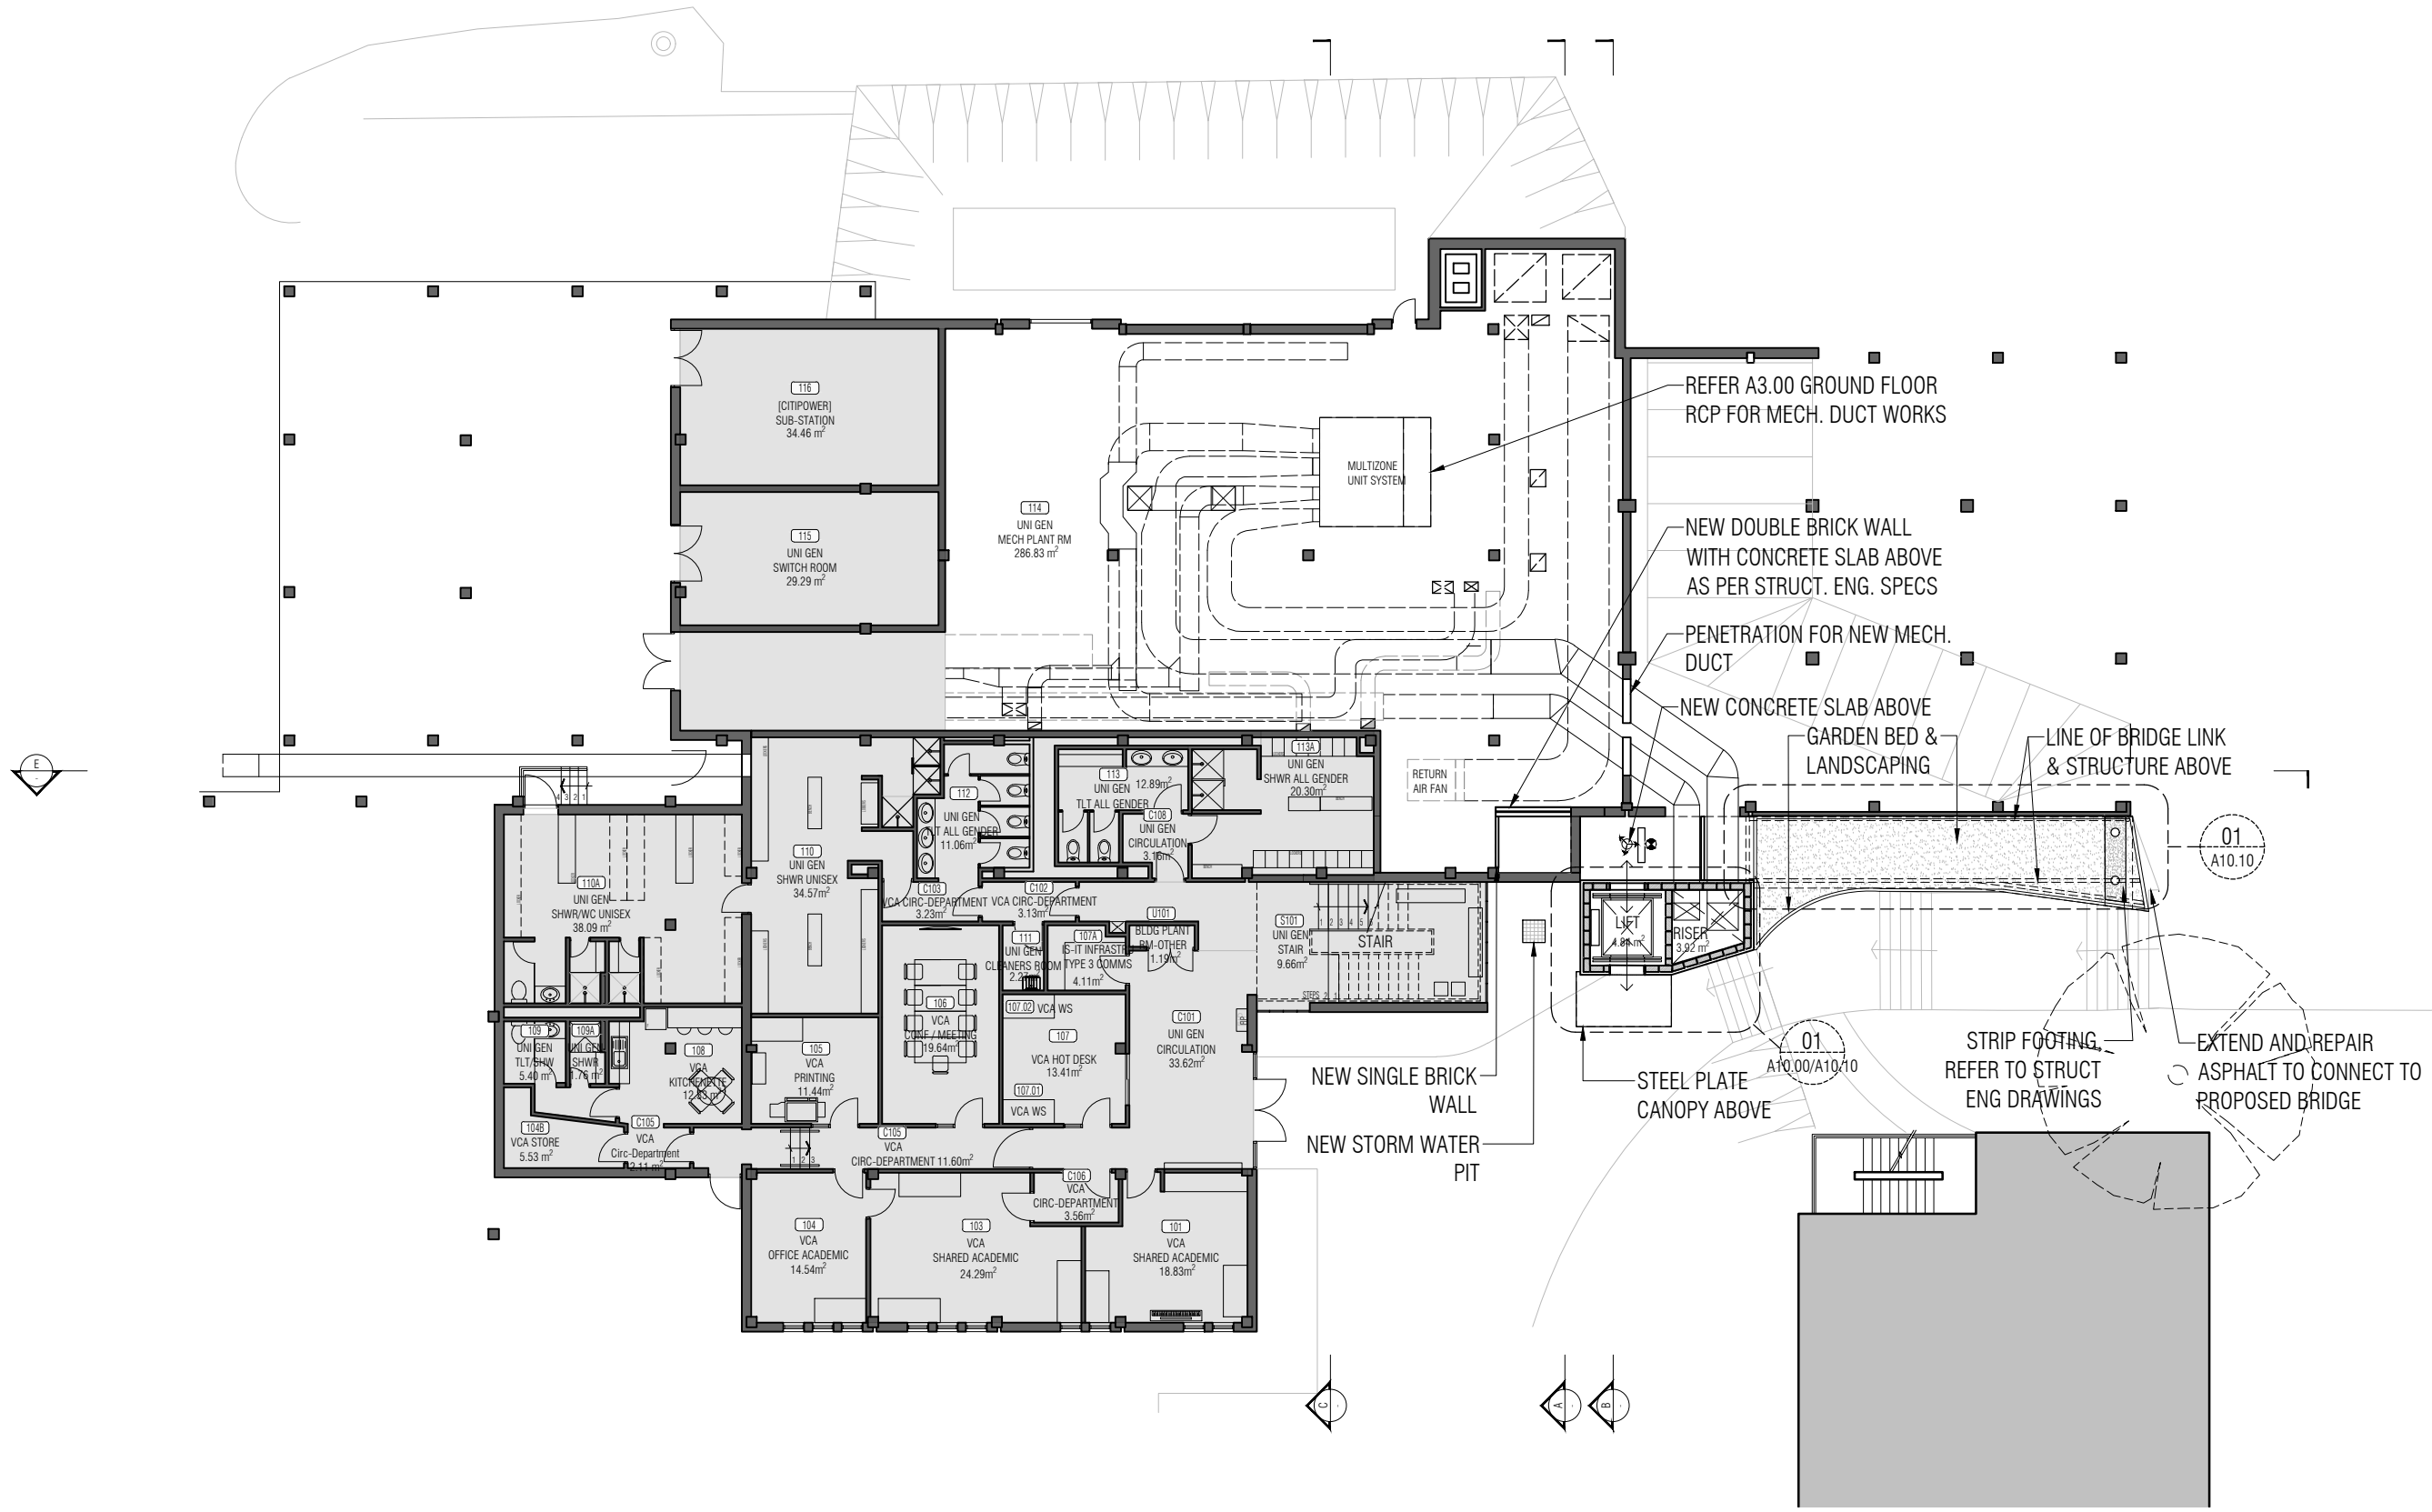

1 PROPOSED PLAN - GROUND FLOOR (LEVEL 1)
1:200@A3

OUT OF SCOPE

ALL DIMENSIONS AND LEVELS TO BE VERIFIED ON SITE BY THE BUILDER BEFORE THE COMMENCEMENT OF ANY WORK. ANY DISCREPANCIES MUST BE REPORTED TO THE ARCHITECT IMMEDIATELY. DO NOT SCALE DRAWINGS. FIGURED DIMENSIONS HAVE PREFERENCE OVER DIMENSIONS SCALED FROM THE DRAWINGS. THESE DRAWINGS TO BE READ IN CONJUNCTION WITH THE SPECIFICATIONS AND OTHER ASSOCIATED DOCUMENTS. REFER TO ENGINEERING SERVICES DRAWINGS FOR CONFIRMATION OF LOCATIONS AND HEIGHT OF FITTINGS, AIR DIFFUSERS, GRILLES, SPRINKLERS, SMOKE DETECTORS, AND ALL OTHER CEILING MOUNTED OR RECESSED SERVICE OUTLETS AND FITTINGS AND ADDITIONAL SET OUT OF CEILING SUPPORT MEMBERS. MAKE ALL PENETRATIONS, CUT OUTS AND TRIM TO SUIT ALL RELEVANT SERVICE OUTLETS AND FITTINGS. ANY DISCREPANCIES BETWEEN THE ARCHITECTURAL AND SERVICES DOCUMENTS ARE TO BE REPORTED TO THE ARCHITECT FOR CLARIFICATION. IN THE EVENT OF DISCREPANCIES, THE CONTRACTOR MUST ALLOW FOR THE HIGHER COST ALTERNATIVE IN THE SCOPE OF WORKS. NOM INDICATES A NOMINAL DIMENSION TO BE CHECKED ON SITE.

REV	DESCRIPTION	DRAWN	DATE
1	FOR COORDINATION	-	08.02.2024
2	FOR COORDINATION	-	29.02.2024
3	FOR COORDINATION	-	10.05.2024
4	FOR HERITAGE PERMIT	-	10.05.2024

CLIENT



VICTORIAN COLLEGE OF THE ARTS
The University of Melbourne

SERVICES ENGINEERING
Caleb Engineers
206 / 7 Jelfcott St,
West Melbourne, VIC 3003.
Ph. 9020 9347

BUILDING SURVEYOR
Wilmore Nelson McDermott
Suite 105/80 Monash Dr,
Dandenong South, VIC 3175.
Ph. 1300 799 543


STRUCTURAL ENGINEERING
Engineering Folk
0413 516 870


COST CONSULTANT

H2o architects Pty Ltd
29 Northumberland Street
Collingwood
Victoria 3066 Australia
T 61 3 9417 0900
F 61 3 9417 0911
studio@h2oarchitects.com.au

PROJECT
**UNIVERSITY OF MELBOURNE
BLDG 864 - PERFORMING ARTS**


DRAWING TITLE
**PROPOSED PLAN
GROUND FLOOR (LEVEL 1)**

DRAWN BY H2o	SCALE 1:200 @ A3	PLOT DATE 10.05.2024
PROJECT NUMBER 2356	FOR HERITAGE PERMIT	
	DRAWING NUMBER A1.00	REVISION 4

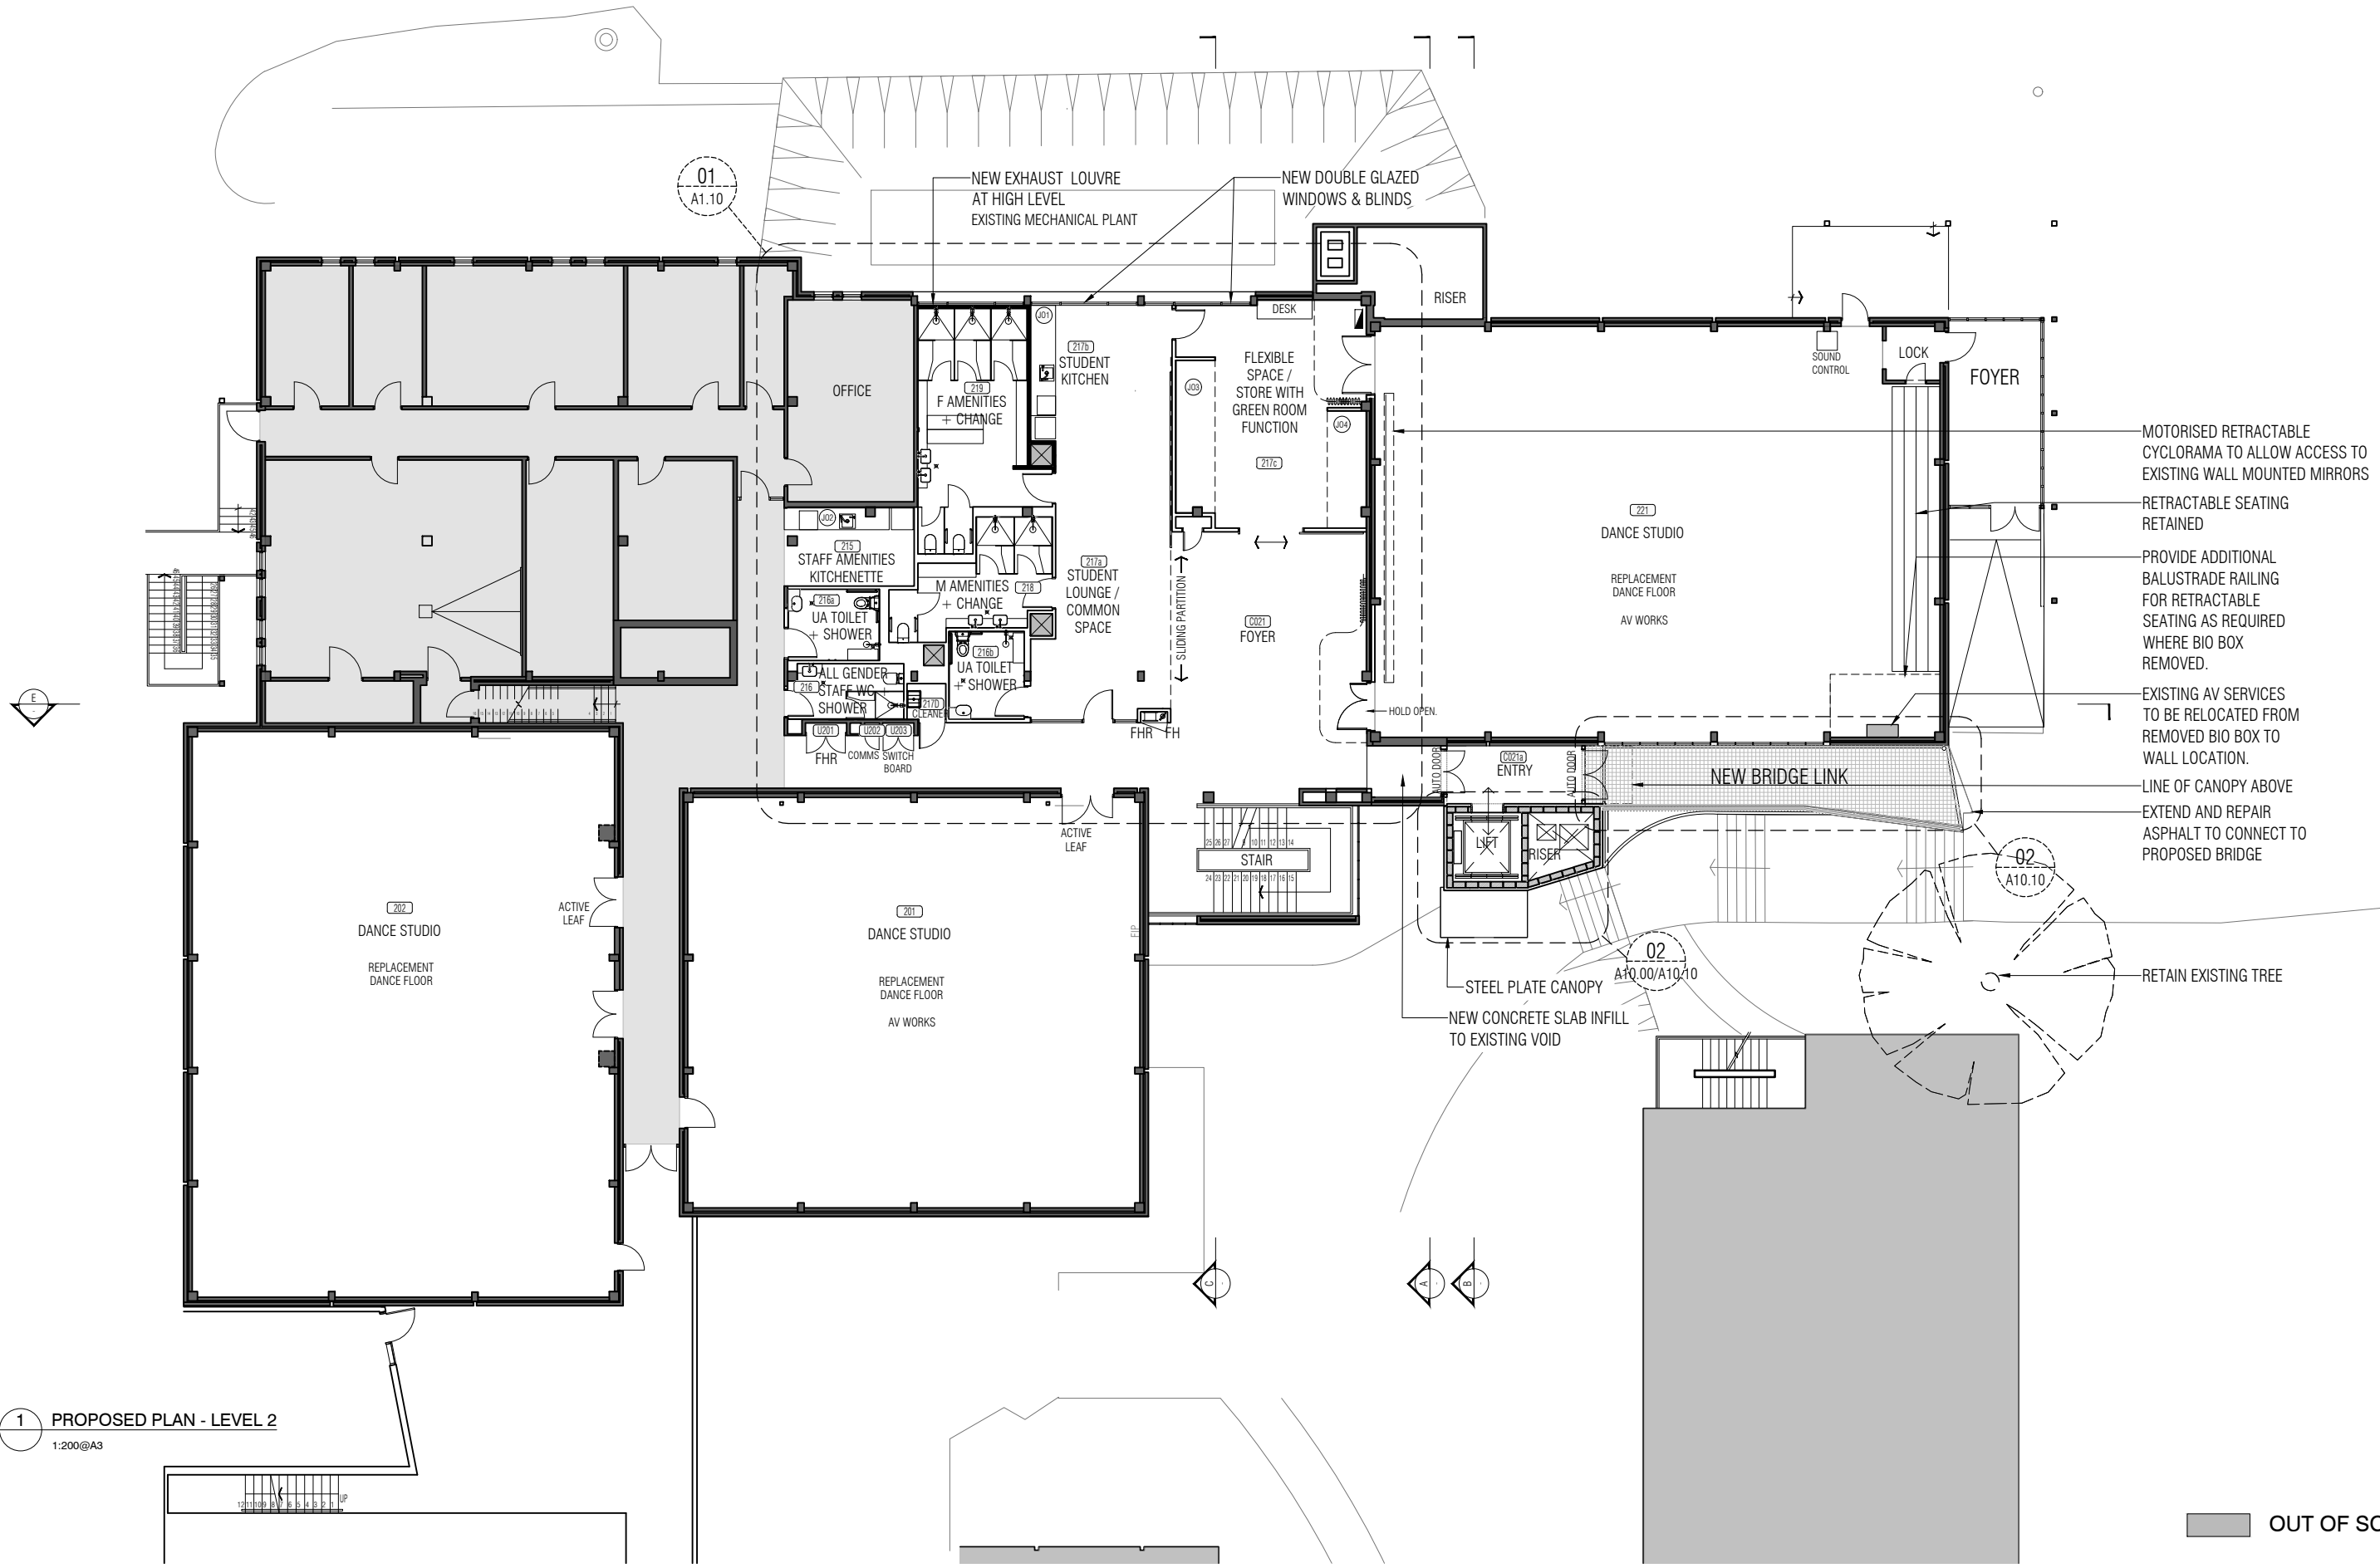

1 PROPOSED PLAN - LEVEL 2
1:200@A3

ALL DIMENSIONS AND LEVELS TO BE VERIFIED ON SITE BY THE BUILDER BEFORE THE COMMENCEMENT OF ANY WORK. ANY DISCREPANCIES MUST BE REPORTED TO THE ARCHITECT IMMEDIATELY. DO NOT SCALE DRAWINGS. FIGURED DIMENSIONS HAVE PREFERENCE OVER DIMENSIONS SCALED FROM THE DRAWINGS. THESE DRAWINGS TO BE READ IN CONJUNCTION WITH THE SPECIFICATIONS AND OTHER ASSOCIATED DOCUMENTS. REFER TO ENGINEERING SERVICES DRAWINGS FOR CONFIRMATION OF LOCATIONS AND HEIGHT OF FITTINGS, AIR DIFFUSERS, GRILLES, SPRINKLERS, SMOKE DETECTORS, AND ALL OTHER CEILING MOUNTED OR RECESSED SERVICE OUTLETS AND FITTINGS AND ADDITIONAL SET OUT OF CEILING SUPPORT MEMBERS. MAKE ALL PENETRATIONS, CUT OUTS AND TRIM TO SUIT ALL RELEVANT SERVICE OUTLETS AND FITTINGS. ANY DISCREPANCIES BETWEEN THE ARCHITECTURAL AND SERVICES DOCUMENTS ARE TO BE REPORTED TO THE ARCHITECT FOR CLARIFICATION. IN THE EVENT OF DISCREPANCIES, THE CONTRACTOR MUST ALLOW FOR THE HIGHER COST ALTERNATIVE IN THE SCOPE OF WORKS. NOM INDICATES A NOMINAL DIMENSION TO BE CHECKED ON SITE.

REV	DESCRIPTION	DRAWN	DATE	CLIENT
1	FOR COORDINATION	-	08.02.2024	 VICTORIAN COLLEGE OF THE ARTS The University of Melbourne
2	FOR COORDINATION	-	02.04.2024	
3	FOR COORDINATION	-	10.05.2024	
4	FOR COORDINATION	-	10.05.2024	

SERVICES ENGINEERING
Caleb Engineers
206 / 7 Jelfcott St,
West Melbourne, VIC 3003.
Ph. 9020 9347

BUILDING SURVEYOR
Wilmore Nelson McDermott
Suite 105/80 Monash Dr,
Dandenong South, VIC 3175.
Ph. 1300 799 543

STRUCTURAL ENGINEERING
Engineering Folk
0413 516 870

COST CONSULTANT

H2o architects Pty Ltd
29 Northumberland Street
Collingwood
Victoria 3066 Australia
T 61 3 9417 0900
F 61 3 9417 0911
studio@h2oarchitects.com.au

H2o

PROJECT
**UNIVERSITY OF MELBOURNE
BLDG 864 - PERFORMING ARTS**

DRAWING TITLE
**PROPOSED PLAN
LEVEL 2**

DRAWN BY
H2o

PROJECT NUMBER
2356

SCALE
1:200 @ A3

PLOT DATE
10.05.2024


FOR HERITAGE PERMIT

DRAWING NUMBER
A1.01

REVISION
4


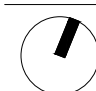
OUT OF SCOPE


7 7 7

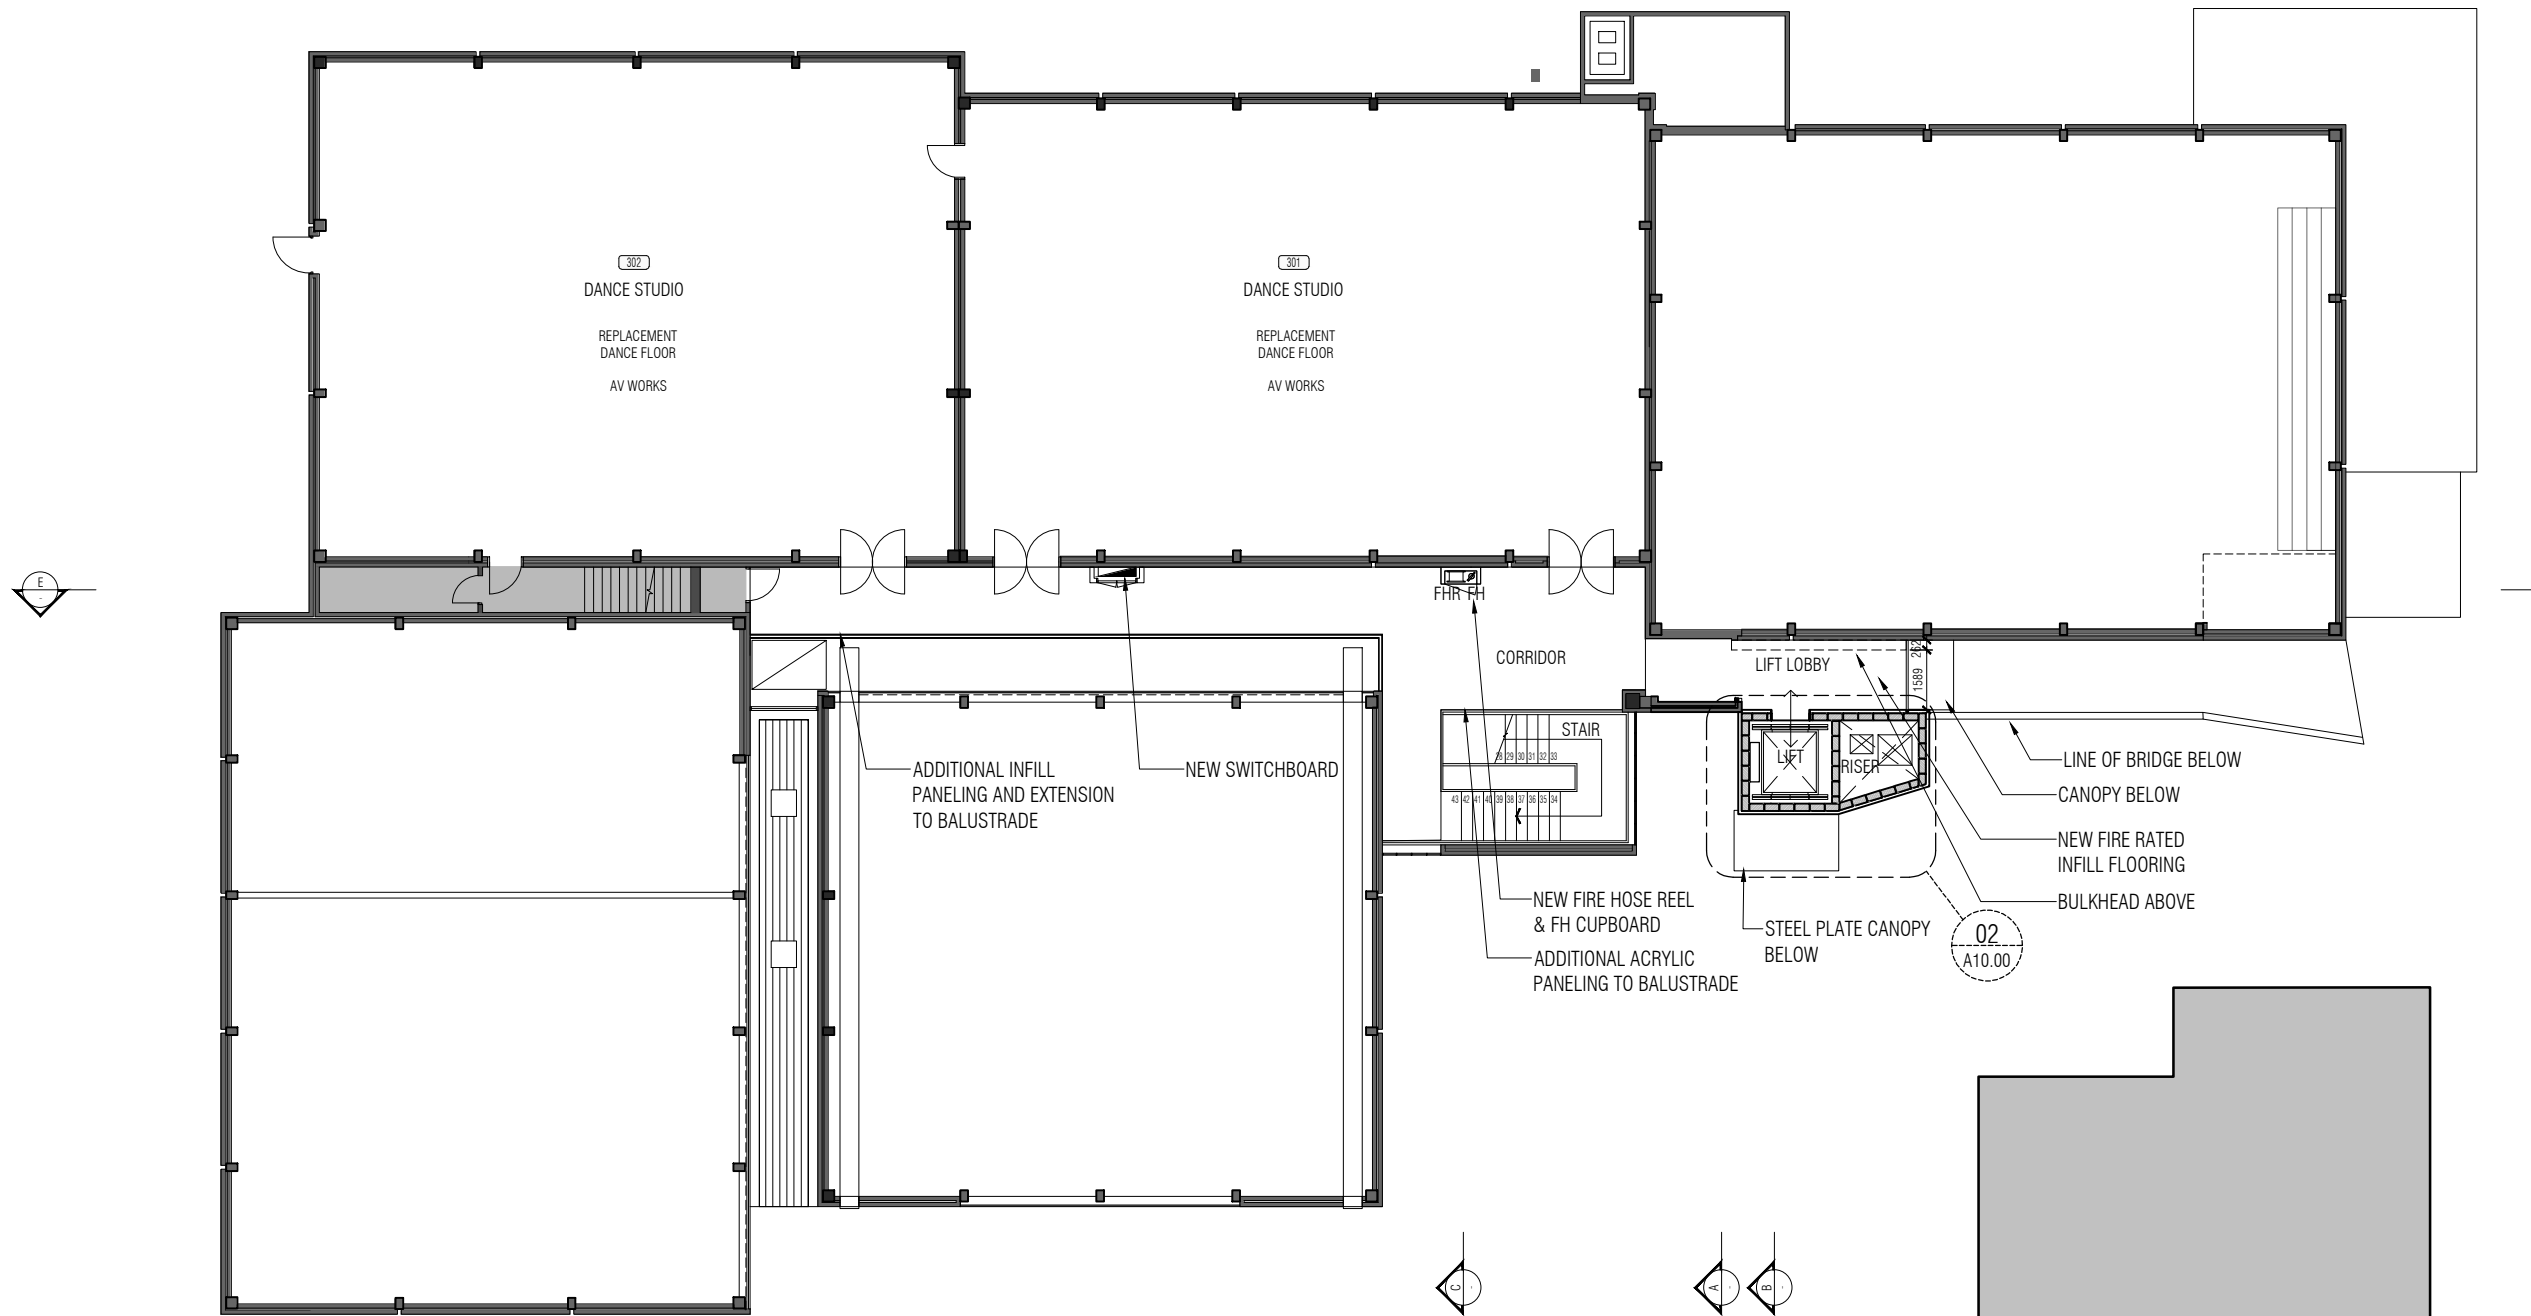

1 PROPOSED PLAN - LEVEL 3
1:200@A3


OUT OF SCOPE

<p>ALL DIMENSIONS AND LEVELS TO BE VERIFIED ON SITE BY THE BUILDER BEFORE THE COMMENCEMENT OF ANY WORK. ANY DISCREPANCIES MUST BE REPORTED TO THE ARCHITECT IMMEDIATELY. DO NOT SCALE DRAWINGS. FIGURED DIMENSIONS HAVE PREFERENCE OVER DIMENSIONS SCALED FROM THE DRAWINGS. THESE DRAWINGS TO BE READ IN CONJUNCTION WITH THE SPECIFICATIONS AND OTHER ASSOCIATED DOCUMENTS. REFER TO ENGINEERING SERVICES DRAWINGS FOR CONFIRMATION OF LOCATIONS AND HEIGHT OF FITTINGS, AIR DIFFUSERS, GRILLES, SPRINKLERS, SMOKE DETECTORS, AND ALL OTHER CEILING MOUNTED OR RECESSED SERVICE OUTLETS AND FITTINGS AND ADDITIONAL SET OUT OF CEILING SUPPORT MEMBERS. MAKE ALL PENETRATIONS, CUT OUTS AND TRIM TO SUIT ALL RELEVANT SERVICE OUTLETS AND FITTINGS. ANY DISCREPANCIES BETWEEN THE ARCHITECTURAL AND SERVICES DOCUMENTS ARE TO BE REPORTED TO THE ARCHITECT FOR CLARIFICATION. IN THE EVENT OF DISCREPANCIES, THE CONTRACTOR MUST ALLOW FOR THE HIGHER COST ALTERNATIVE IN THE SCOPE OF WORKS. NOM INDICATES A NOMINAL DIMENSION TO BE CHECKED ON SITE.</p>	<table border="1"> <thead> <tr> <th>REV</th> <th>DESCRIPTION</th> <th>DRAWN</th> <th>DATE</th> </tr> </thead> <tbody> <tr> <td>1</td> <td>FOR COORDINATION</td> <td>-</td> <td>08.02.2024</td> </tr> <tr> <td>2</td> <td>FOR HERITAGE PERMIT</td> <td>-</td> <td>10.05.2024</td> </tr> </tbody> </table>	REV	DESCRIPTION	DRAWN	DATE	1	FOR COORDINATION	-	08.02.2024	2	FOR HERITAGE PERMIT	-	10.05.2024	<p>CLIENT</p>  <p>VICTORIAN COLLEGE OF THE ARTS The University of Melbourne</p>	<p>SERVICES ENGINEERING</p> <p>Caleb Engineers 206 / 7 Jellicott St, West Melbourne, VIC 3003. Ph. 9020 9347</p>	<p>BUILDING SURVEYOR</p> <p>Wilmore Nelson McDermott Suite 105/80 Monash Dr, Dandenong South, VIC 3175. Ph. 1300 799 543</p>	<p>STRUCTURAL ENGINEERING</p> <p>Engineering Folk 0413 516 870</p>	<p>COST CONSULTANT</p>	<p>H2o architects Pty Ltd 29 Northumberland Street Collingwood Victoria 3066 Australia T 61 3 9417 0900 F 61 3 9417 0911 studio@h2oarchitects.com.au</p>	<p>PROJECT</p> <p>UNIVERSITY OF MELBOURNE BLDG 864 - PERFORMING ARTS</p>	<p>DRAWN BY</p> <p>H2o</p>	<p>PROJECT NUMBER</p> <p>2356</p>	<p>SCALE</p> <p>1:200 @ A3</p>	<p>PLOT DATE</p> <p>10.05.2024</p>
	REV	DESCRIPTION	DRAWN	DATE																				
1	FOR COORDINATION	-	08.02.2024																					
2	FOR HERITAGE PERMIT	-	10.05.2024																					
<p>DRAWING TITLE</p> <p>PROPOSED PLAN LEVEL 3</p>		<p>DRAWING NUMBER</p> <p>A1.02</p>	<p>REVISION</p> <p>2</p>																					

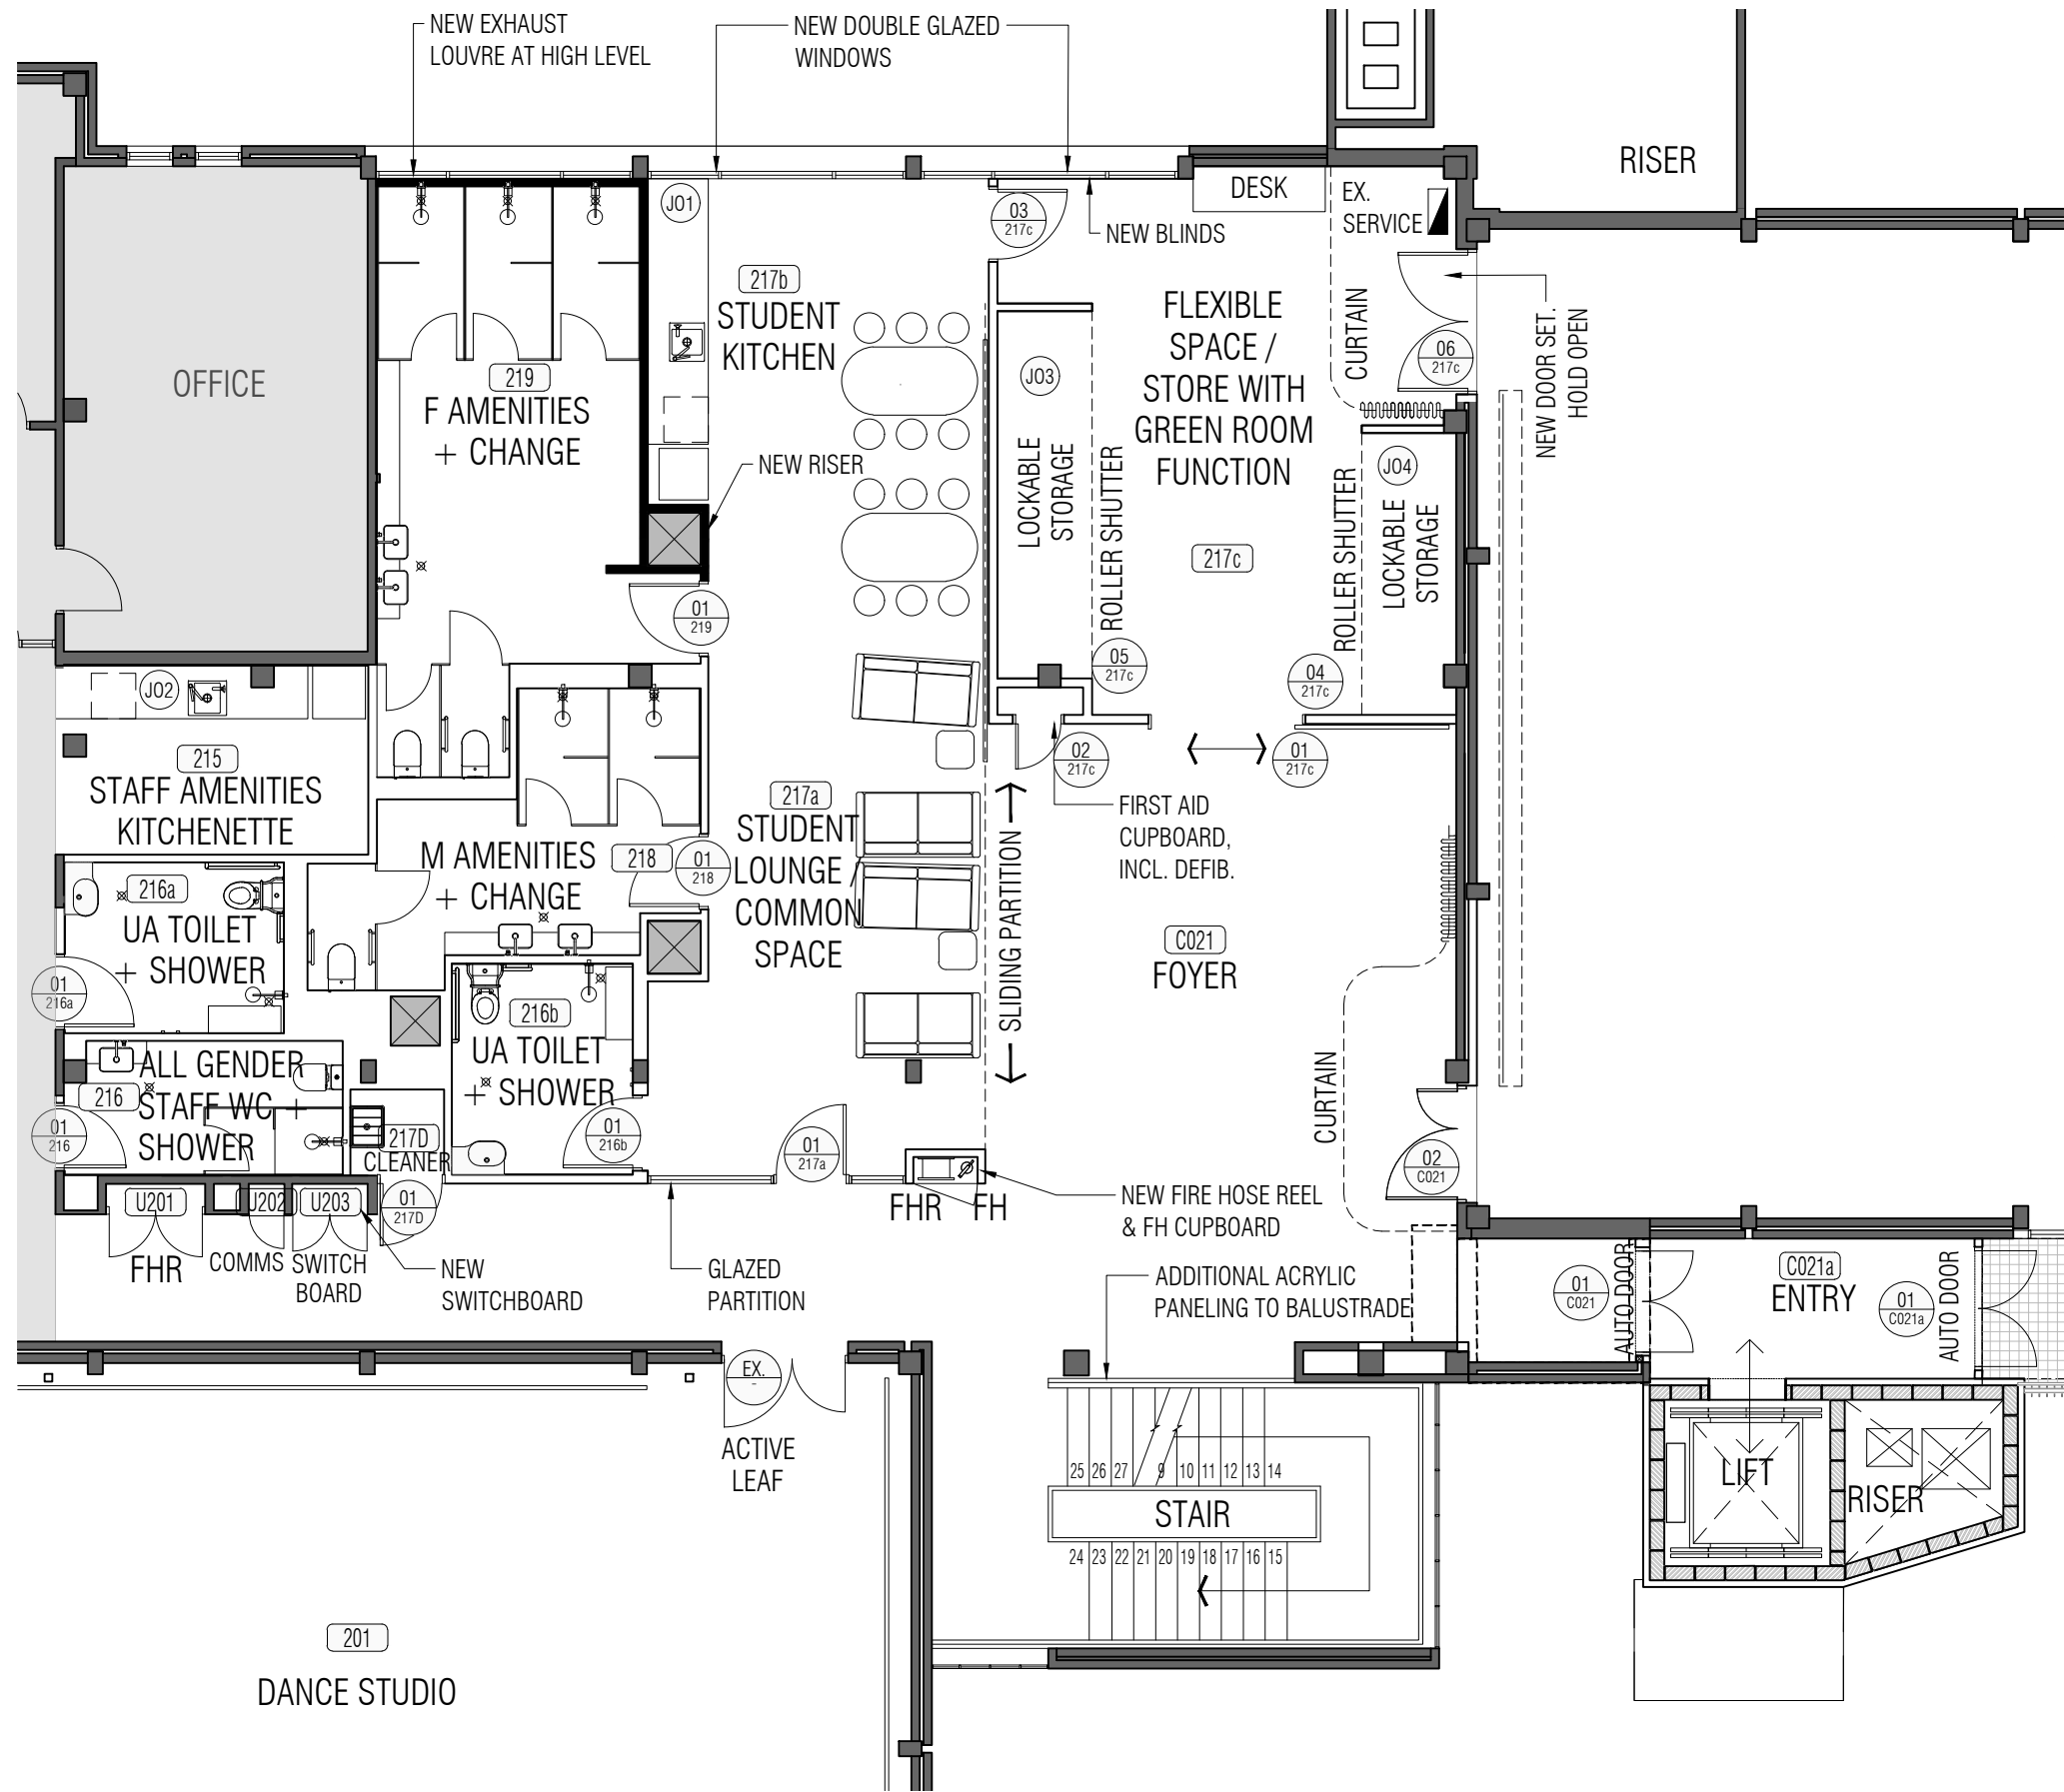

1 PROPOSED PLAN - LEVEL 2
1:100@A3

ALL DIMENSIONS AND LEVELS TO BE VERIFIED ON SITE BY THE BUILDER BEFORE THE COMMENCEMENT OF ANY WORK. ANY DISCREPANCIES MUST BE REPORTED TO THE ARCHITECT IMMEDIATELY. DO NOT SCALE DRAWINGS. FIGURED DIMENSIONS HAVE PREFERENCE OVER DIMENSIONS SCALED FROM THE DRAWINGS. THESE DRAWINGS TO BE READ IN CONJUNCTION WITH THE SPECIFICATIONS AND OTHER ASSOCIATED DOCUMENTS. REFER TO ENGINEERING SERVICES DRAWINGS FOR CONFIRMATION OF LOCATIONS AND HEIGHT OF FITTINGS, AIR DIFFUSERS, GRILLES, SPRINKLERS, SMOKE DETECTORS, AND ALL OTHER CEILING MOUNTED OR RECESSED SERVICE OUTLETS AND FITTINGS AND ADDITIONAL SET OUT OF CEILING SUPPORT MEMBERS. MAKE ALL PENETRATIONS, CUT OUTS AND TRIM TO SUIT ALL RELEVANT SERVICE OUTLETS AND FITTINGS. ANY DISCREPANCIES BETWEEN THE ARCHITECTURAL AND SERVICES DOCUMENTS ARE TO BE REPORTED TO THE ARCHITECT FOR CLARIFICATION. IN THE EVENT OF DISCREPANCIES, THE CONTRACTOR MUST ALLOW FOR THE HIGHER COST ALTERNATIVE IN THE SCOPE OF WORKS. NOM INDICATES A NOMINAL DIMENSION TO BE CHECKED ON SITE.

REV	DESCRIPTION	DRAWN	DATE	CLIENT
1	FOR COORDINATION	-	08.02.2024	 VICTORIAN COLLEGE OF THE ARTS The University of Melbourne
2	FOR COORDINATION	-	02.04.2024	
3	FOR COORDINATION	-	10.05.2024	
4	FOR HERITAGE PERMIT	-	10.05.2024	

SERVICES ENGINEERING
Caleb Engineers
206 / 7 Jelfcott St,
West Melbourne, VIC 3003.
Ph. 9020 9347

BUILDING SURVEYOR
Wilmore Nelson McDermott
Suite 105/80 Monash Dr,
Dandenong South, VIC 3175.
Ph. 1300 799 543

STRUCTURAL ENGINEERING
Engineering Folk
0413 516 870

COST CONSULTANT

H2o architects Pty Ltd
25 Northumberland Street
Collingwood
Victoria 3066 Australia
T 61 3 9417 0900
F 61 3 9417 0911
studio@h2oarchitects.com.au


H2o

PROJECT
**UNIVERSITY OF MELBOURNE
BLDG 864 - PERFORMING ARTS**

DRAWING TITLE
**PROPOSED PLAN
LEVEL 2 AMENITIES**

DRAWN BY
H2o

PROJECT NUMBER
2356




SCALE
1:100 @ A3

PLOT DATE
10.05.2024

FOR HERITAGE PERMIT


DRAWING NUMBER
A1.10

REVISION
4

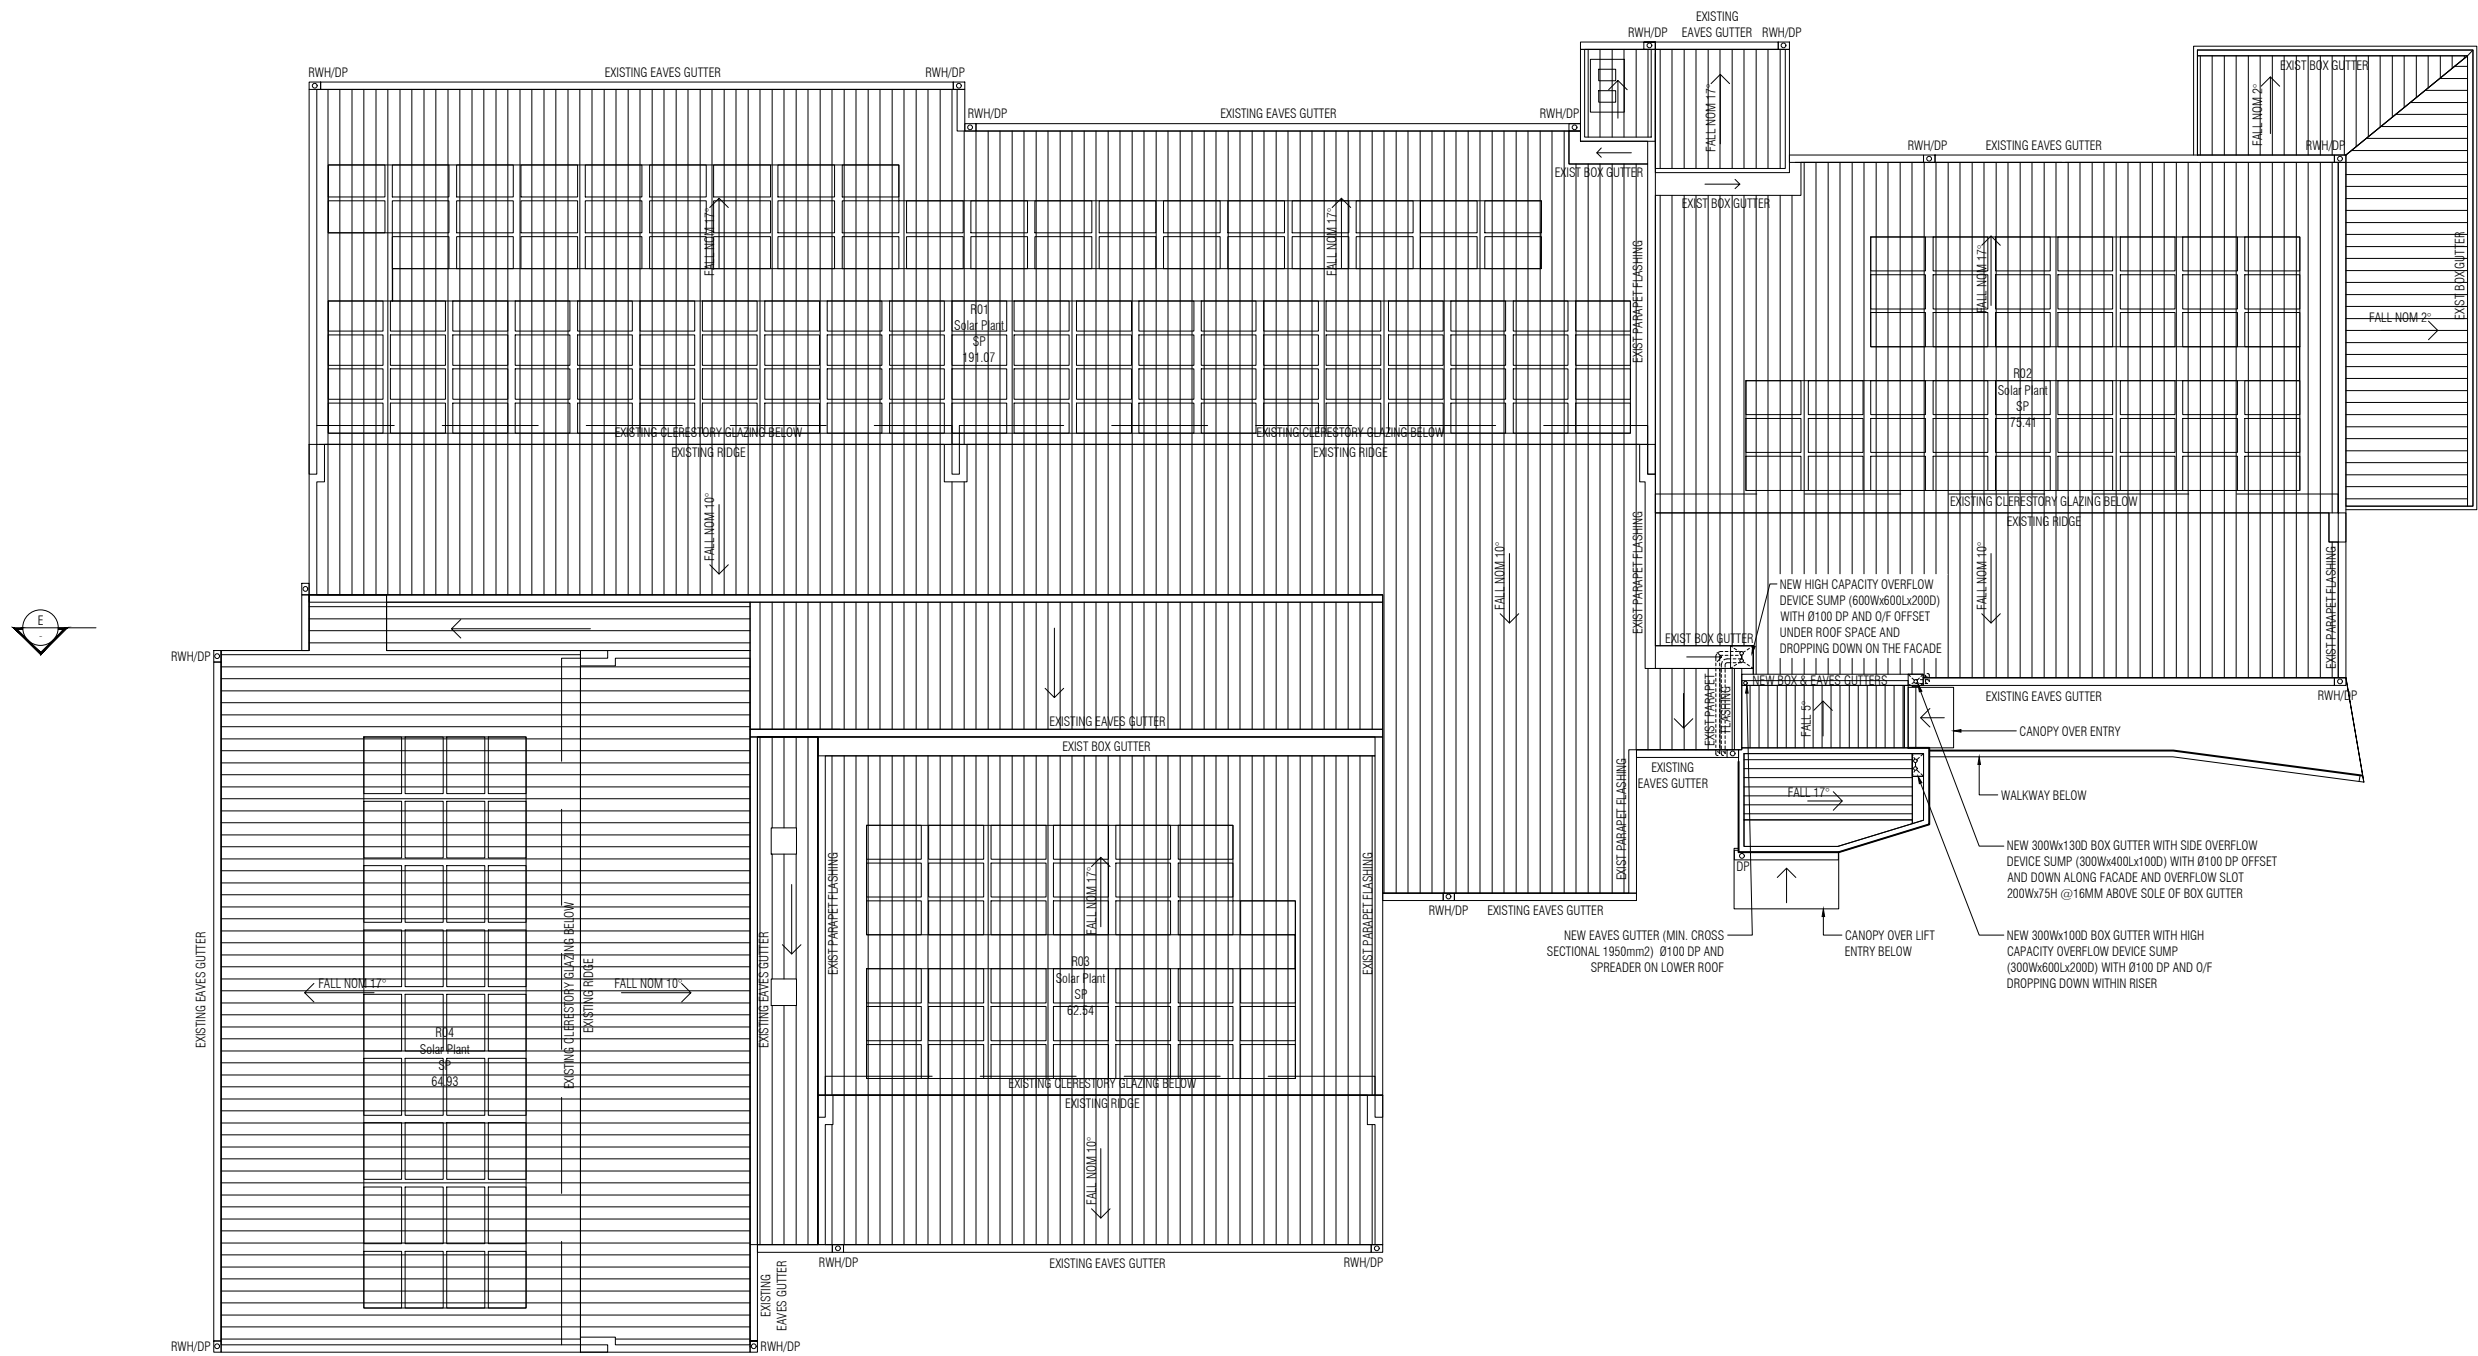

1 EXISTING PLAN - ROOF
1:200@A3

ALL DIMENSIONS AND LEVELS TO BE VERIFIED ON SITE BY THE BUILDER BEFORE THE COMMENCEMENT OF ANY WORK. ANY DISCREPANCIES MUST BE REPORTED TO THE ARCHITECT IMMEDIATELY. DO NOT SCALE DRAWINGS. FIGURED DIMENSIONS HAVE PREFERENCE OVER DIMENSIONS SCALED FROM THE DRAWINGS. THESE DRAWINGS TO BE READ IN CONJUNCTION WITH THE SPECIFICATIONS AND OTHER ASSOCIATED DOCUMENTS. REFER TO ENGINEERING SERVICES DRAWINGS FOR CONFIRMATION OF LOCATIONS AND HEIGHT OF FITTINGS, AIR DIFFUSERS, GRILLES, SPRINKLERS, SMOKE DETECTORS, AND ALL OTHER CEILING MOUNTED OR RECESSED SERVICE OUTLETS AND FITTINGS AND ADDITIONAL SET OUT OF CEILING SUPPORT MEMBERS. MAKE ALL PENETRATIONS, CUT OUTS AND TRIM TO SUIT ALL RELEVANT SERVICE OUTLETS AND FITTINGS. ANY DISCREPANCIES BETWEEN THE ARCHITECTURAL AND SERVICES DOCUMENTS ARE TO BE REPORTED TO THE ARCHITECT FOR CLARIFICATION. IN THE EVENT OF DISCREPANCIES, THE CONTRACTOR MUST ALLOW FOR THE HIGHER COST ALTERNATIVE IN THE SCOPE OF WORKS. NOM INDICATES A NOMINAL DIMENSION TO BE CHECKED ON SITE.

REV	DESCRIPTION	DRAWN	DATE	CLIENT
1	FOR COORDINATION	-	19/04/2024	 VICTORIAN COLLEGE OF THE ARTS The University of Melbourne
2	FOR COORDINATION	-	10.05.2024	
3	FOR HERITAGE PERMIT	-	10.05.2024	

SERVICES ENGINEERING
Caleb Engineers
206 / 7 Jelfcott St,
West Melbourne, VIC 3003.
Ph. 9020 9347

BUILDING SURVEYOR
Wilmore Nelson McDermott
Suite 105/80 Monash Dr,
Dandenong South, VIC 3175.
Ph. 1300 799 543

STRUCTURAL ENGINEERING
Engineering Folk
0413 516 870

COST CONSULTANT

H2o architects Pty Ltd
29 Northumberland Street
Collingwood
Victoria 3066 Australia
T 61 3 9417 0900
F 61 3 9417 0911
studio@h2oarchitects.com.au

PROJECT
**UNIVERSITY OF MELBOURNE
BLDG 864 - PERFORMING ARTS**

DRAWING TITLE
PROPOSED ROOF PLAN

DRAWN BY
H2o

PROJECT NUMBER
2356


SCALE
1:200 @ A3


PLOT DATE
10.05.2024

FOR HERITAGE PERMIT


DRAWING NUMBER
A1.20

REVISION
3



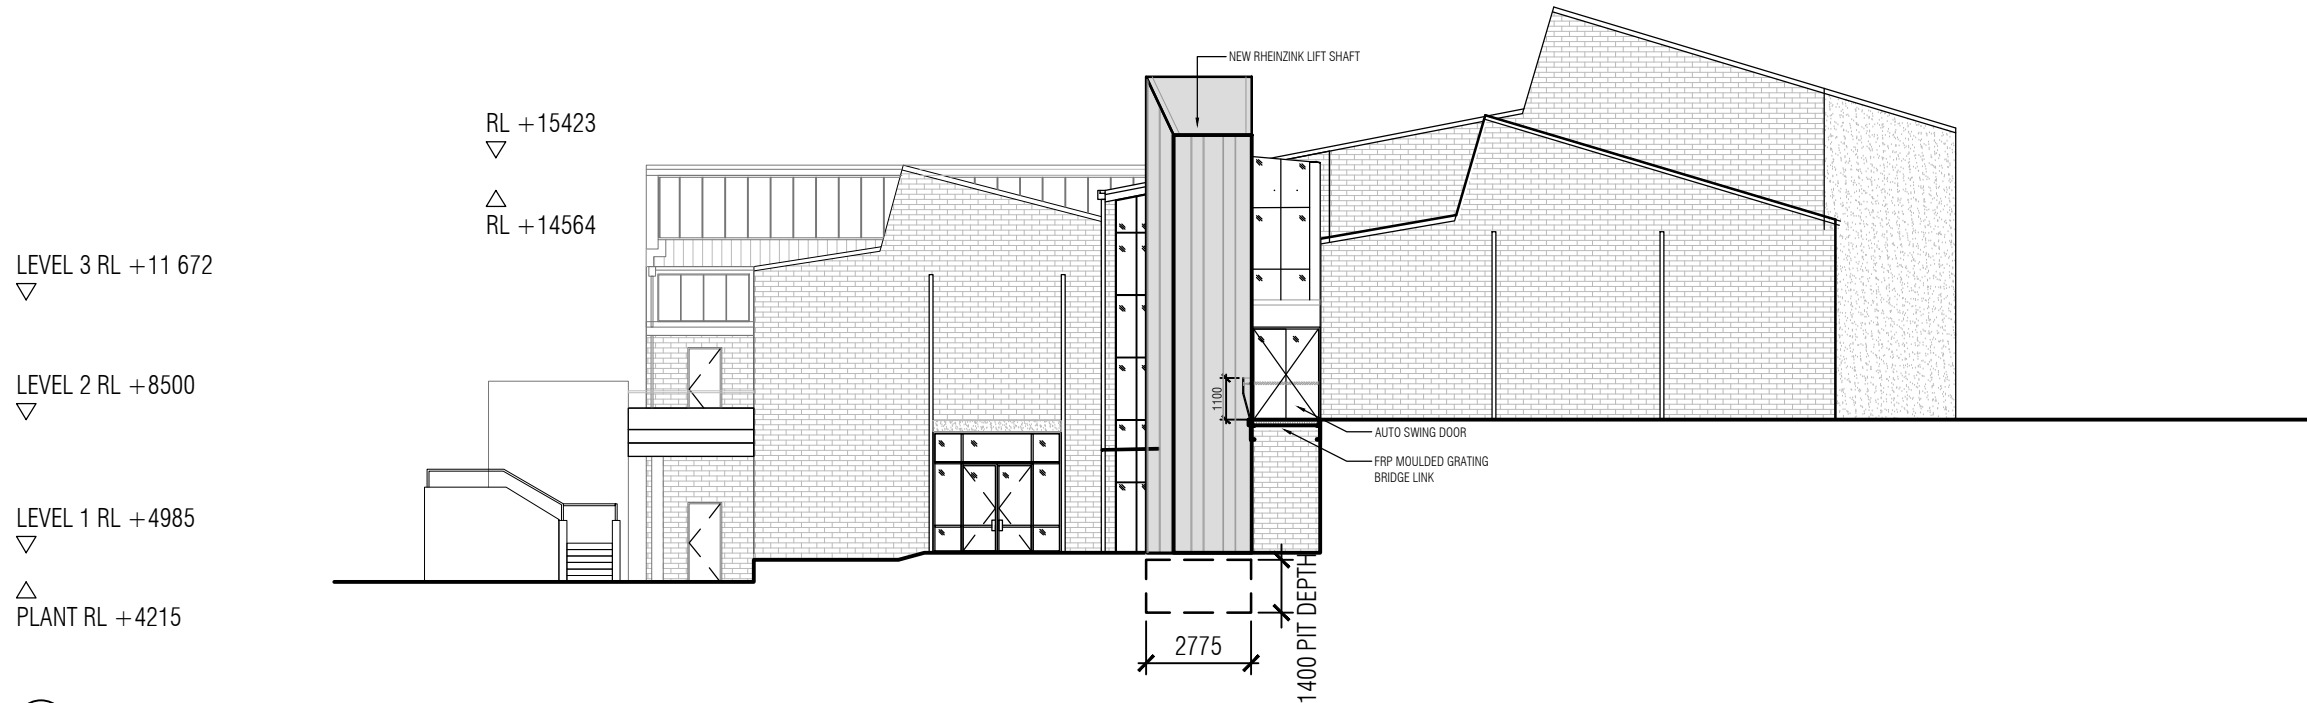

1 PROPOSED EAST ELEVATION
1:200@A3

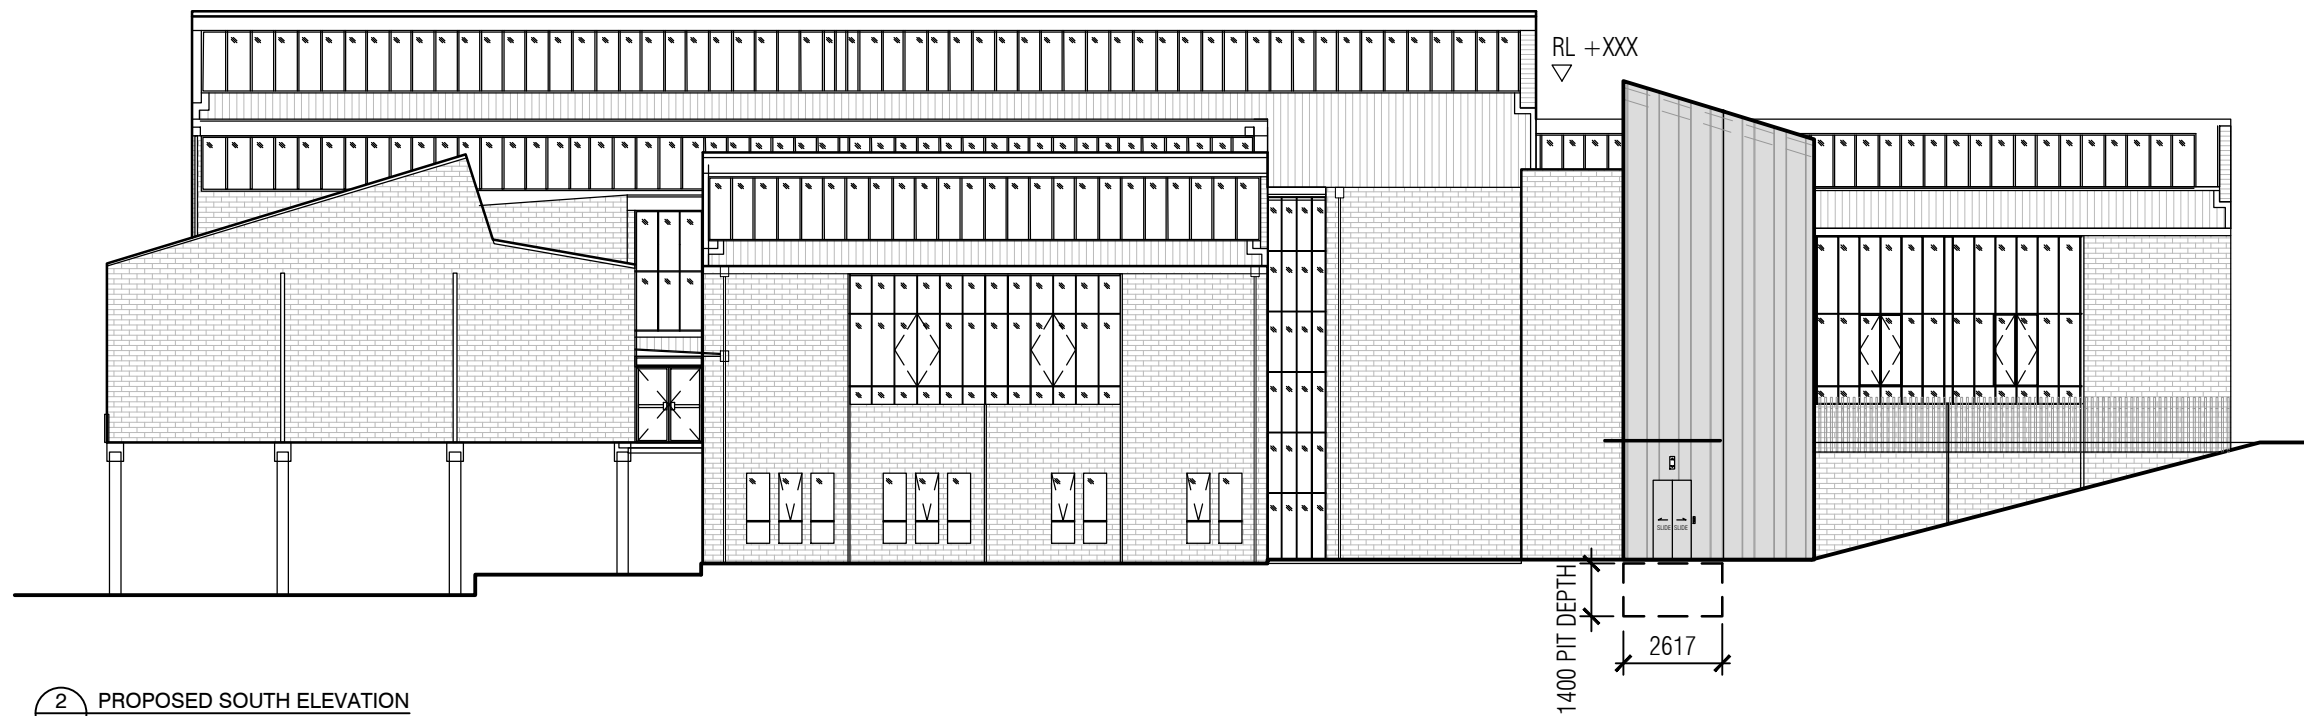

2 PROPOSED SOUTH ELEVATION
1:200@A3

ALL DIMENSIONS AND LEVELS TO BE VERIFIED ON SITE BY THE BUILDER BEFORE THE COMMENCEMENT OF ANY WORK. ANY DISCREPANCIES MUST BE REPORTED TO THE ARCHITECT IMMEDIATELY. DO NOT SCALE DRAWINGS. FIGURED DIMENSIONS HAVE PREFERENCE OVER DIMENSIONS SCALED FROM THE DRAWINGS. THESE DRAWINGS TO BE READ IN CONJUNCTION WITH THE SPECIFICATIONS AND OTHER ASSOCIATED DOCUMENTS. REFER TO ENGINEERING SERVICES DRAWINGS FOR CONFIRMATION OF LOCATIONS AND HEIGHT OF FITTINGS, AIR DIFFUSERS, GRILLES, SPRINKLERS, SMOKE DETECTORS, AND ALL OTHER CEILING MOUNTED OR RECESSED SERVICE OUTLETS AND FITTINGS AND ADDITIONAL SET OUT OF CEILING SUPPORT MEMBERS. MAKE ALL PENETRATIONS, CUT OUTS AND TRIM TO SUIT ALL RELEVANT SERVICE OUTLETS AND FITTINGS. ANY DISCREPANCIES BETWEEN THE ARCHITECTURAL AND SERVICES DOCUMENTS ARE TO BE REPORTED TO THE ARCHITECT FOR CLARIFICATION. IN THE EVENT OF DISCREPANCIES, THE CONTRACTOR MUST ALLOW FOR THE HIGHER COST ALTERNATIVE IN THE SCOPE OF WORKS. NOM INDICATES A NOMINAL DIMENSION TO BE CHECKED ON SITE.

REV	DESCRIPTION	DRAWN	DATE
1	FOR COORDINATION	-	29.02.2024
2	FOR COORDINATION	-	10.05.2024
3	FOR HERITAGE PERMIT	-	10.05.2024

CLIENT



VICTORIAN COLLEGE OF THE ARTS
The University of Melbourne

SERVICES ENGINEERING
Caleb Engineers
206 / 7 Jelfcott St,
West Melbourne, VIC 3003.
Ph. 9020 9347

BUILDING SURVEYOR
Wilmore Nelson McDermott
Suite 105/80 Monash Dr,
Dandenong South, VIC 3175.
Ph. 1300 799 543

STRUCTURAL ENGINEERING
Engineering Folk
0413 516 870


COST CONSULTANT

H2o architects Pty Ltd
29 Northumberland Street
Collingwood
Victoria 3066 Australia
T 61 3 9417 0900
F 61 3 9417 0911
studio@h2oarchitects.com.au

PROJECT
**UNIVERSITY OF MELBOURNE
BLDG 864 - PERFORMING ARTS**

DRAWING TITLE
PROPOSED ELEVATIONS

DRAWN BY H2o	SCALE 1:200 @ A3	PLOT DATE 10.05.2024
PROJECT NUMBER 2356	FOR HERITAGE PERMIT	
DRAWING NUMBER A5.02	REVISION 3	

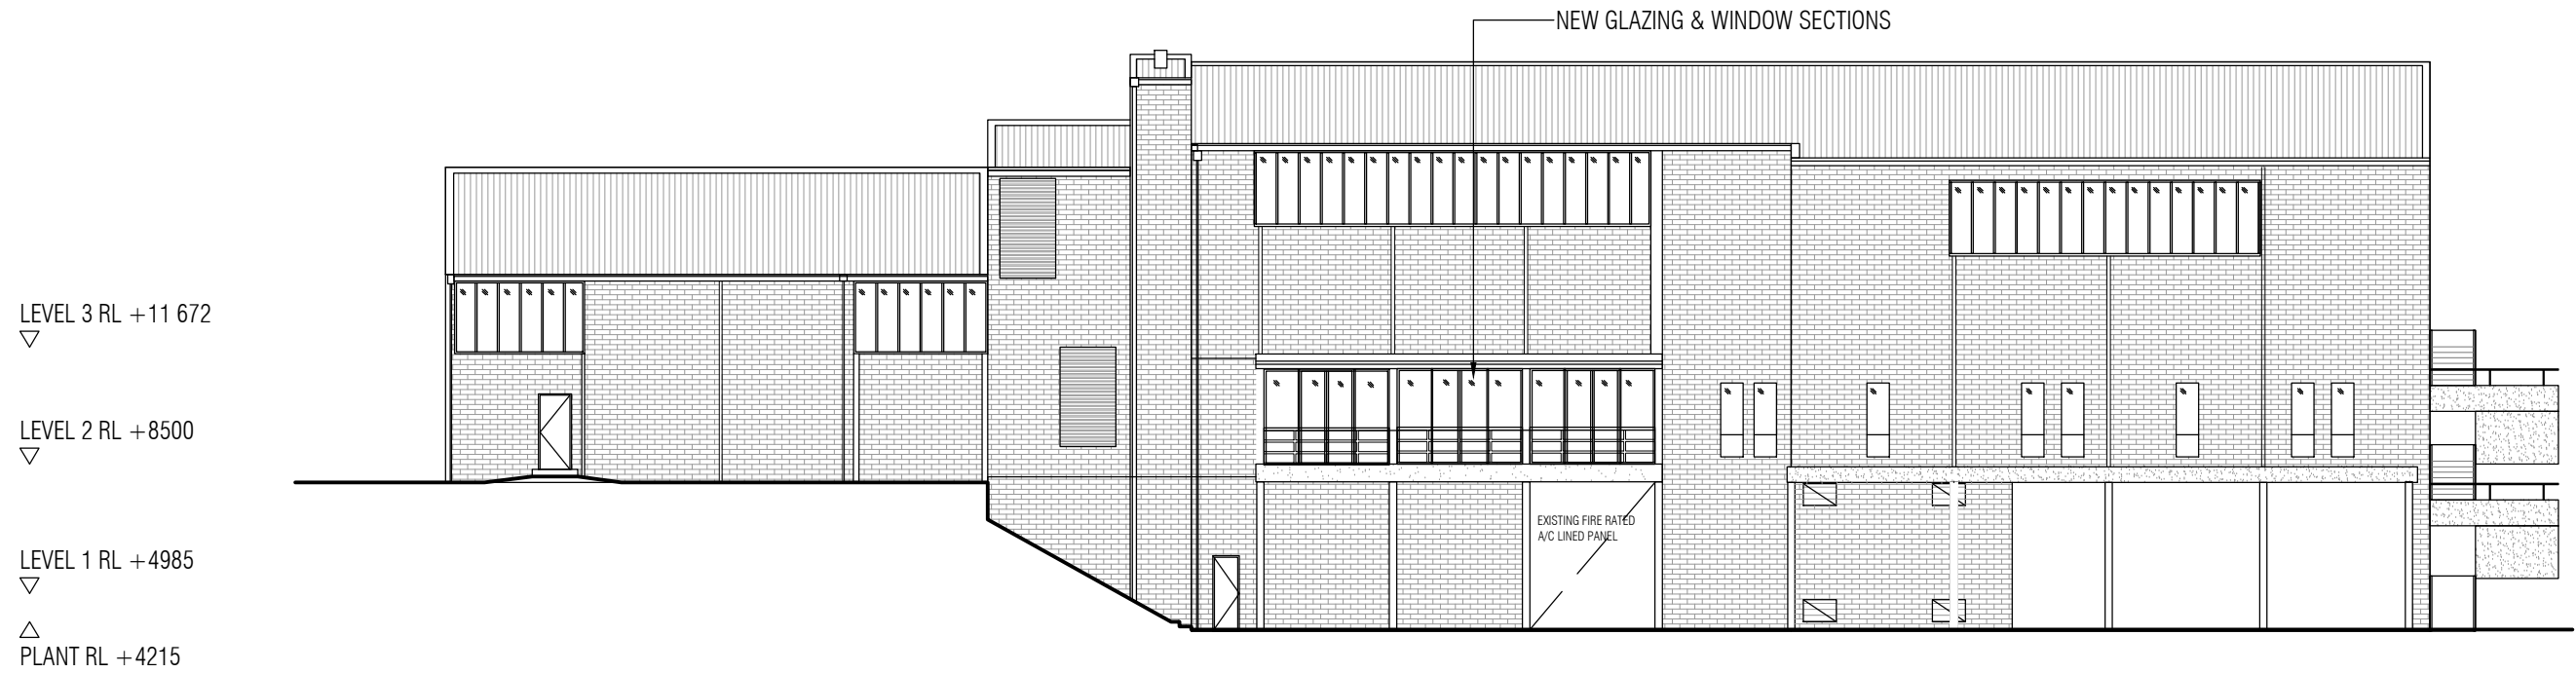

1 PROPOSED NORTH ELEVATION
1:200@A3

ALL DIMENSIONS AND LEVELS TO BE VERIFIED ON SITE BY THE BUILDER BEFORE THE COMMENCEMENT OF ANY WORK. ANY DISCREPANCIES MUST BE REPORTED TO THE ARCHITECT IMMEDIATELY. DO NOT SCALE DRAWINGS. FIGURED DIMENSIONS HAVE PREFERENCE OVER DIMENSIONS SCALED FROM THE DRAWINGS. THESE DRAWINGS TO BE READ IN CONJUNCTION WITH THE SPECIFICATIONS AND OTHER ASSOCIATED DOCUMENTS. REFER TO ENGINEERING SERVICES DRAWINGS FOR CONFIRMATION OF LOCATIONS AND HEIGHT OF FITTINGS, AIR DIFFUSERS, GRILLES, SPRINKLERS, SMOKE DETECTORS, AND ALL OTHER CEILING MOUNTED OR RECESSED SERVICE OUTLETS AND FITTINGS AND ADDITIONAL SET OUT OF CEILING SUPPORT MEMBERS. MAKE ALL PENETRATIONS, CUT OUTS AND TRIM TO SUIT ALL RELEVANT SERVICE OUTLETS AND FITTINGS. ANY DISCREPANCIES BETWEEN THE ARCHITECTURAL AND SERVICES DOCUMENTS ARE TO BE REPORTED TO THE ARCHITECT FOR CLARIFICATION. IN THE EVENT OF DISCREPANCIES, THE CONTRACTOR MUST ALLOW FOR THE HIGHER COST ALTERNATIVE IN THE SCOPE OF WORKS. NOM INDICATES A NOMINAL DIMENSION TO BE CHECKED ON SITE.

REV	DESCRIPTION	DRAWN	DATE
1	FOR COORDINATION	-	29.02.2024
2	FOR COORDINATION	-	10.05.2024
3	FOR HERITAGE PERMIT	-	10.05.2024

CLIENT



VICTORIAN COLLEGE OF THE ARTS
The University of Melbourne

SERVICES ENGINEERING
Caleb Engineers
206 / 7 Jellicott St,
West Melbourne, VIC 3003.
Ph. 9020 9347

BUILDING SURVEYOR
Wilmore Nelson McDermott
Suite 105/80 Monash Dr,
Dandenong South, VIC 3175.
Ph. 1300 799 543

STRUCTURAL ENGINEERING
Engineering Folk
0413 516 870

COST CONSULTANT

H2o architects Pty Ltd
29 Northumberland Street
Collingwood
Victoria 3066 Australia
T 61 3 9417 0900
F 61 3 9417 0911
studio@h2oarchitects.com.au

PROJECT
**UNIVERSITY OF MELBOURNE
BLDG 864 - PERFORMING ARTS**

DRAWING TITLE
PROPOSED ELEVATIONS

DRAWN BY
H2o

PROJECT NUMBER
2356


SCALE
1:200 @ A3

PLOT DATE
10.05.2024


FOR HERITAGE PERMIT

DRAWING NUMBER
A5.03


REVISION
3

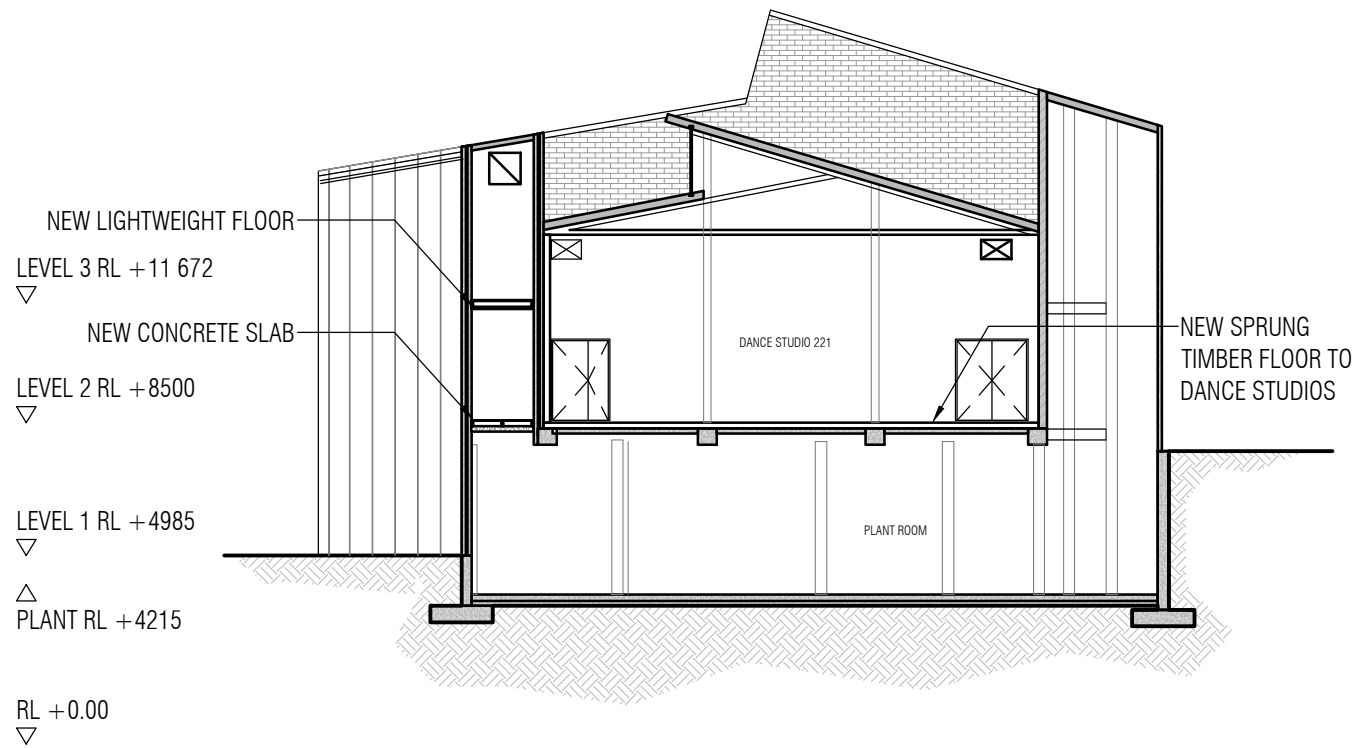

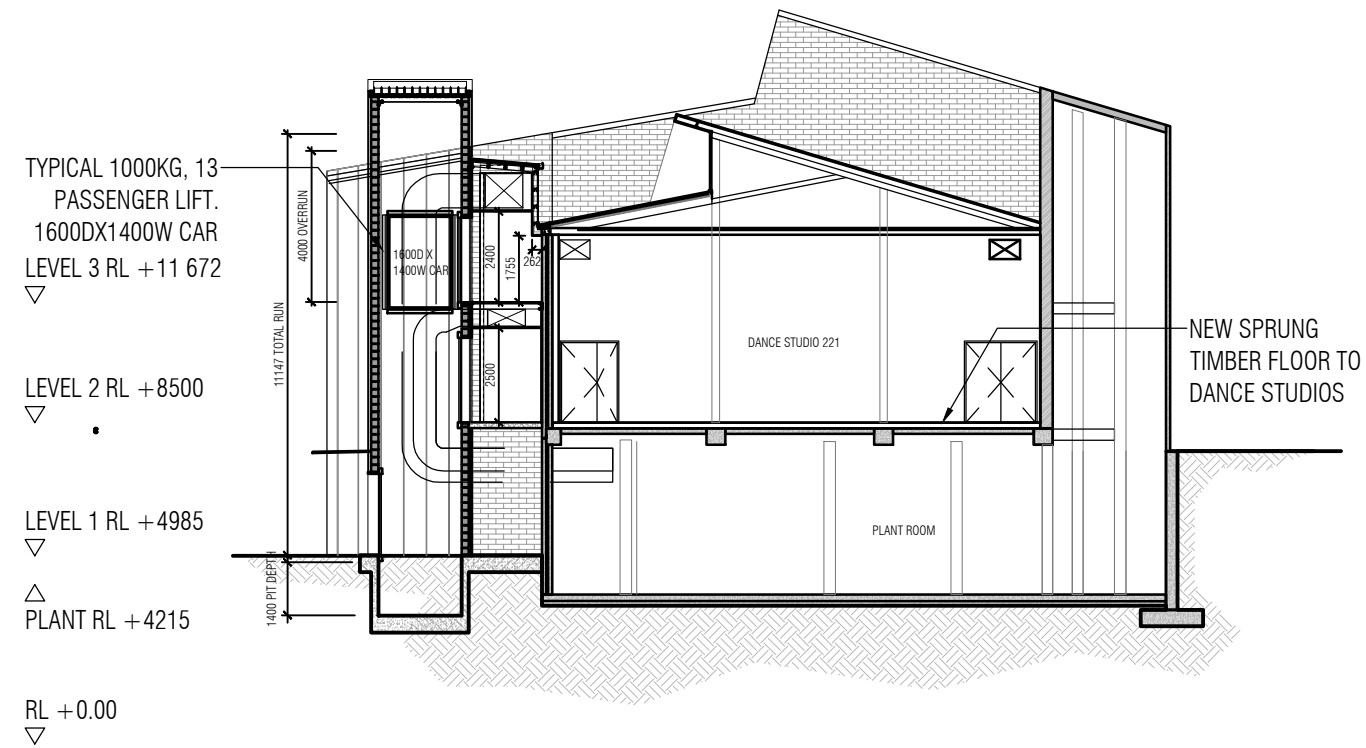

A PROPOSED SECTION A
1:200@A3

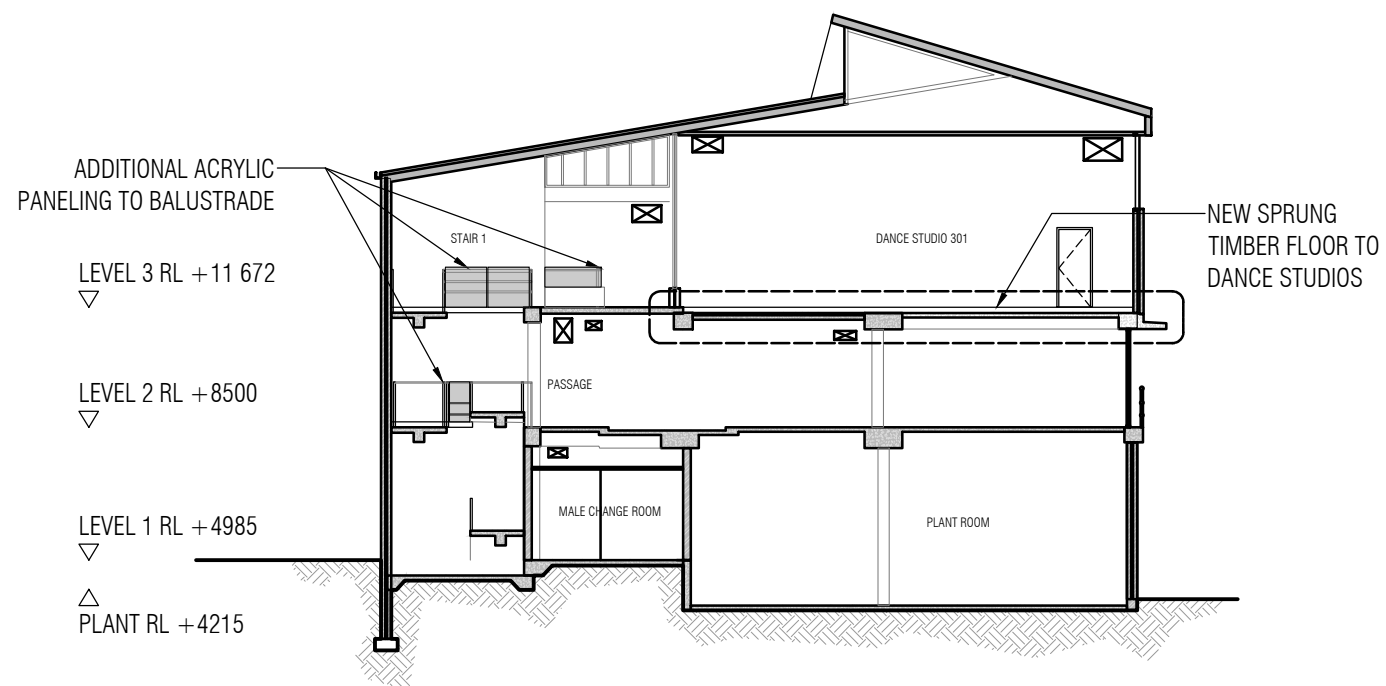

B PROPOSED SECTION B
1:200@A3



C PROPOSED SECTION C
1:200@A3

<p>ALL DIMENSIONS AND LEVELS TO BE VERIFIED ON SITE BY THE BUILDER BEFORE THE COMMENCEMENT OF ANY WORK. ANY DISCREPANCIES MUST BE REPORTED TO THE ARCHITECT IMMEDIATELY. DO NOT SCALE DRAWINGS. FIGURED DIMENSIONS HAVE PREFERENCE OVER DIMENSIONS SCALED FROM THE DRAWINGS. THESE DRAWINGS TO BE READ IN CONJUNCTION WITH THE SPECIFICATIONS AND OTHER ASSOCIATED DOCUMENTS. REFER TO ENGINEERING SERVICES DRAWINGS FOR CONFIRMATION OF LOCATIONS AND HEIGHT OF FITTINGS, AIR DIFFUSERS, GRILLES, SPRINKLERS, SMOKE DETECTORS, AND ALL OTHER CEILING MOUNTED OR RECESSED SERVICE OUTLETS AND FITTINGS AND ADDITIONAL SET OUT OF CEILING SUPPORT MEMBERS. MAKE ALL PENETRATIONS, CUT OUTS AND TRIM TO SUIT ALL RELEVANT SERVICE OUTLETS AND FITTINGS. ANY DISCREPANCIES BETWEEN THE ARCHITECTURAL AND SERVICES DOCUMENTS ARE TO BE REPORTED TO THE ARCHITECT FOR CLARIFICATION. IN THE EVENT OF DISCREPANCIES, THE CONTRACTOR MUST ALLOW FOR THE HIGHER COST ALTERNATIVE IN THE SCOPE OF WORKS. NOM INDICATES A NOMINAL DIMENSION TO BE CHECKED ON SITE.</p>	<table border="1"> <thead> <tr> <th>REV</th> <th>DESCRIPTION</th> <th>DRAWN</th> <th>DATE</th> </tr> </thead> <tbody> <tr> <td>1</td> <td>FOR COORDINATION</td> <td>-</td> <td>29.02.2024</td> </tr> <tr> <td>2</td> <td>FOR COORDINATION</td> <td>-</td> <td>10.05.2024</td> </tr> <tr> <td>3</td> <td>FOR HERITAGE PERMIT</td> <td>-</td> <td>10.05.2024</td> </tr> </tbody> </table>	REV	DESCRIPTION	DRAWN	DATE	1	FOR COORDINATION	-	29.02.2024	2	FOR COORDINATION	-	10.05.2024	3	FOR HERITAGE PERMIT	-	10.05.2024	<p>CLIENT</p>  <p>VICTORIAN COLLEGE OF THE ARTS The University of Melbourne</p>	<p>SERVICES ENGINEERING</p> <p>Caleb Engineers 206 / 7 Jelfcott St, West Melbourne, VIC 3003. Ph. 9020 9347</p>	<p>BUILDING SURVEYOR</p> <p>Wilmore Nelson McDermott Suite 105/80 Monash Dr, Dandenong South, VIC 3175. Ph. 1300 799 543</p>	<p>H2o architects Pty Ltd 29 Northumberland Street Collingwood Victoria 3066 Australia T 61 3 9417 0900 F 61 3 9417 0911 studio@h2oarchitects.com.au</p>	<p>PROJECT</p> <p>UNIVERSITY OF MELBOURNE BLDG 864 - PERFORMING ARTS</p>	<p>DRAWN BY</p> <p>H2o</p> <p>PROJECT NUMBER</p> <p>2356</p>	<p>SCALE</p> <p>1:200 @ A3</p> <p>PLOT DATE</p> <p>10.05.2024</p>	<p>DRAWING TITLE</p> <p>PROPOSED SECTIONS</p>	<p>DRAWING NUMBER</p> <p>A6.00</p>	<p>REVISION</p> <p>3</p>
	REV	DESCRIPTION	DRAWN	DATE																							
	1	FOR COORDINATION	-	29.02.2024																							
2	FOR COORDINATION	-	10.05.2024																								
3	FOR HERITAGE PERMIT	-	10.05.2024																								
																											
<p>FOR HERITAGE PERMIT</p>																											

ADDITIONAL ACRYLIC
PANELING TO BALUSTRADE


LEVEL 3 RL +11 672

LEVEL 2 RL +8500

LEVEL 1 RL +4985

△
PLANT RL +4215

RL +0.00

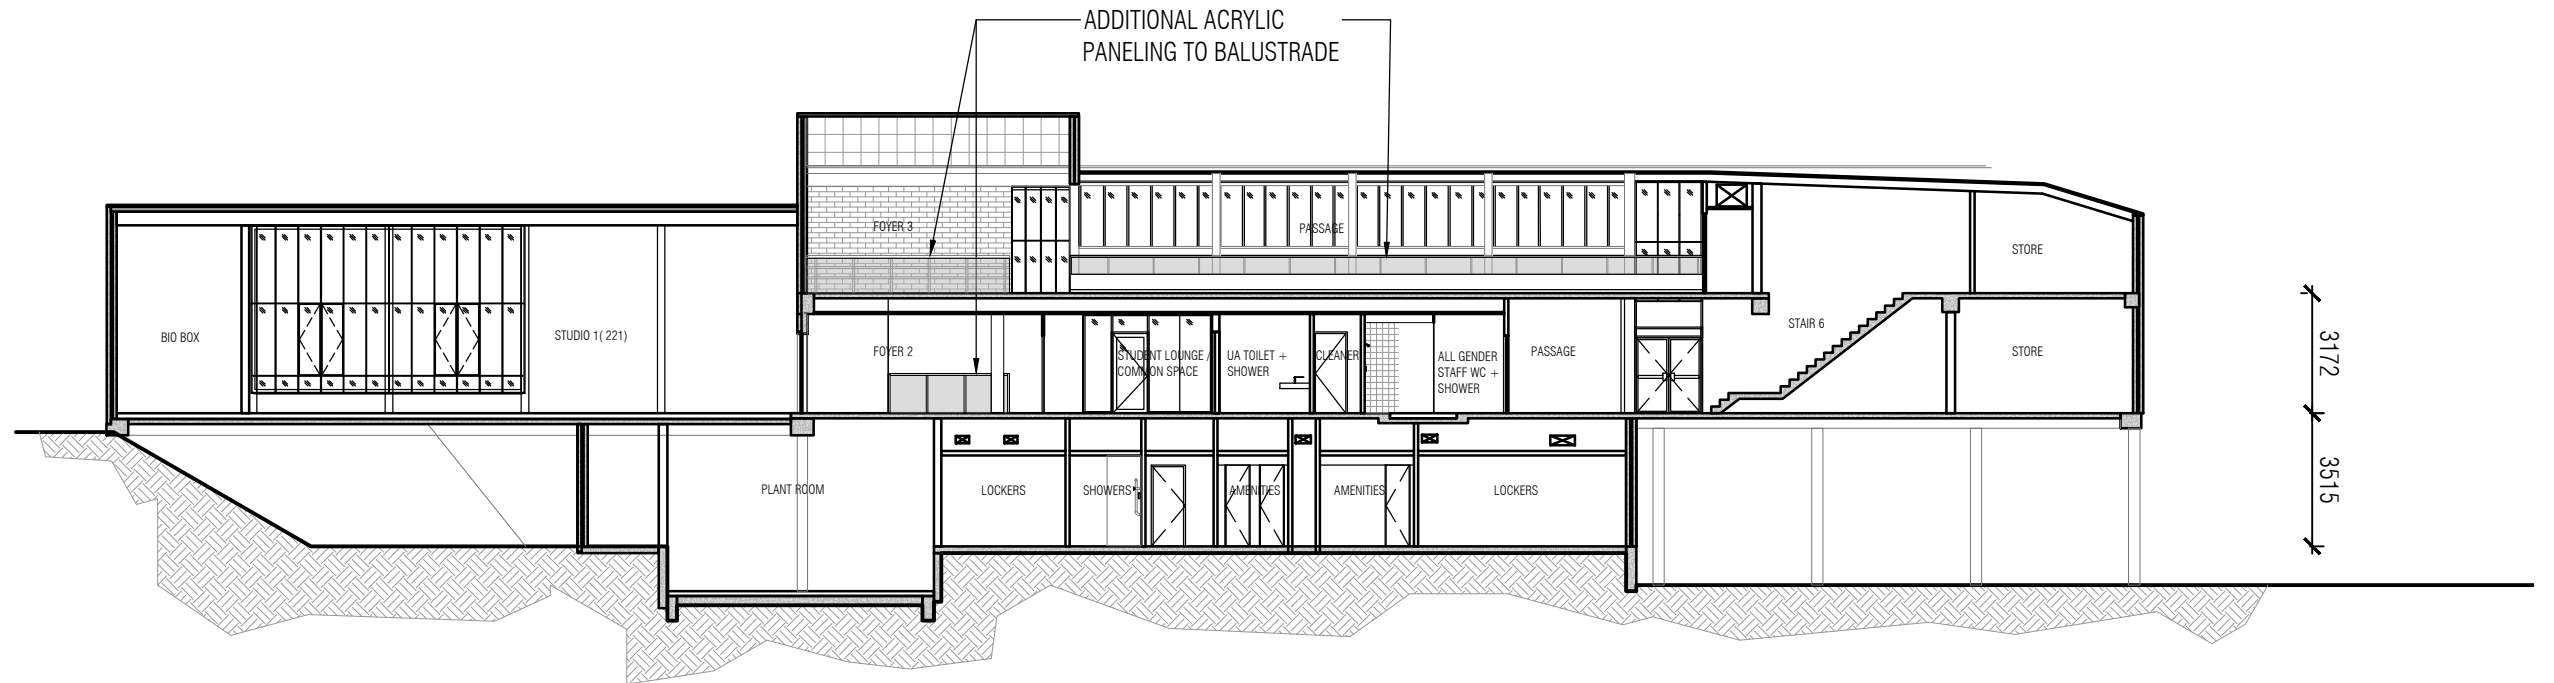

A PROPOSED SECTION G
1:200@A3

ALL DIMENSIONS AND LEVELS TO BE VERIFIED ON SITE BY THE BUILDER BEFORE THE COMMENCEMENT OF ANY WORK. ANY DISCREPANCIES MUST BE REPORTED TO THE ARCHITECT IMMEDIATELY. DO NOT SCALE DRAWINGS. FIGURED DIMENSIONS HAVE PREFERENCE OVER DIMENSIONS SCALED FROM THE DRAWINGS. THESE DRAWINGS TO BE READ IN CONJUNCTION WITH THE SPECIFICATIONS AND OTHER ASSOCIATED DOCUMENTS. REFER TO ENGINEERING SERVICES DRAWINGS FOR CONFIRMATION OF LOCATIONS AND HEIGHT OF FITTINGS, AIR DIFFUSERS, GRILLES, SPRINKLERS, SMOKE DETECTORS, AND ALL OTHER CEILING MOUNTED OR RECESSED SERVICE OUTLETS AND FITTINGS AND ADDITIONAL SET OUT OF CEILING SUPPORT MEMBERS. MAKE ALL PENETRATIONS, CUT OUTS AND TRIM TO SUIT ALL RELEVANT SERVICE OUTLETS AND FITTINGS. ANY DISCREPANCIES BETWEEN THE ARCHITECTURAL AND SERVICES DOCUMENTS ARE TO BE REPORTED TO THE ARCHITECT FOR CLARIFICATION. IN THE EVENT OF DISCREPANCIES, THE CONTRACTOR MUST ALLOW FOR THE HIGHER COST ALTERNATIVE IN THE SCOPE OF WORKS. NOM INDICATES A NOMINAL DIMENSION TO BE CHECKED ON SITE.

REV	DESCRIPTION	DRAWN	DATE
1	FOR COORDINATION	-	01.03.2024
2	FOR COORDINATION	-	10.05.2024
3	FOR HERITAGE PERMIT	H2o	10.05.2024

CLIENT



VICTORIAN COLLEGE OF THE ARTS
The University of Melbourne

SERVICES ENGINEERING
Caleb Engineers
206 / 7 Jelfcott St,
West Melbourne, VIC 3003.
Ph. 9020 9347

BUILDING SURVEYOR
Wilmore Nelson McDermott
Suite 105/80 Monash Dr,
Dandenong South, VIC 3175.
Ph. 1300 799 543

STRUCTURAL ENGINEERING
Engineering Folk
0413 516 870

COST CONSULTANT


H2o architects Pty Ltd
29 Northumberland Street
Collingwood
Victoria 3066 Australia
T 61 3 9417 0900
F 61 3 9417 0911
studio@h2oarchitects.com.au

PROJECT
**UNIVERSITY OF MELBOURNE
BLDG 864 - PERFORMING ARTS**

DRAWING TITLE
PROPOSED SECTIONS

DRAWN BY
H2o

PROJECT NUMBER
2356




SCALE
1:200 @ A3

PLOT DATE
10.05.2024


FOR HERITAGE PERMIT

DRAWING NUMBER
A6.01

REVISION
3

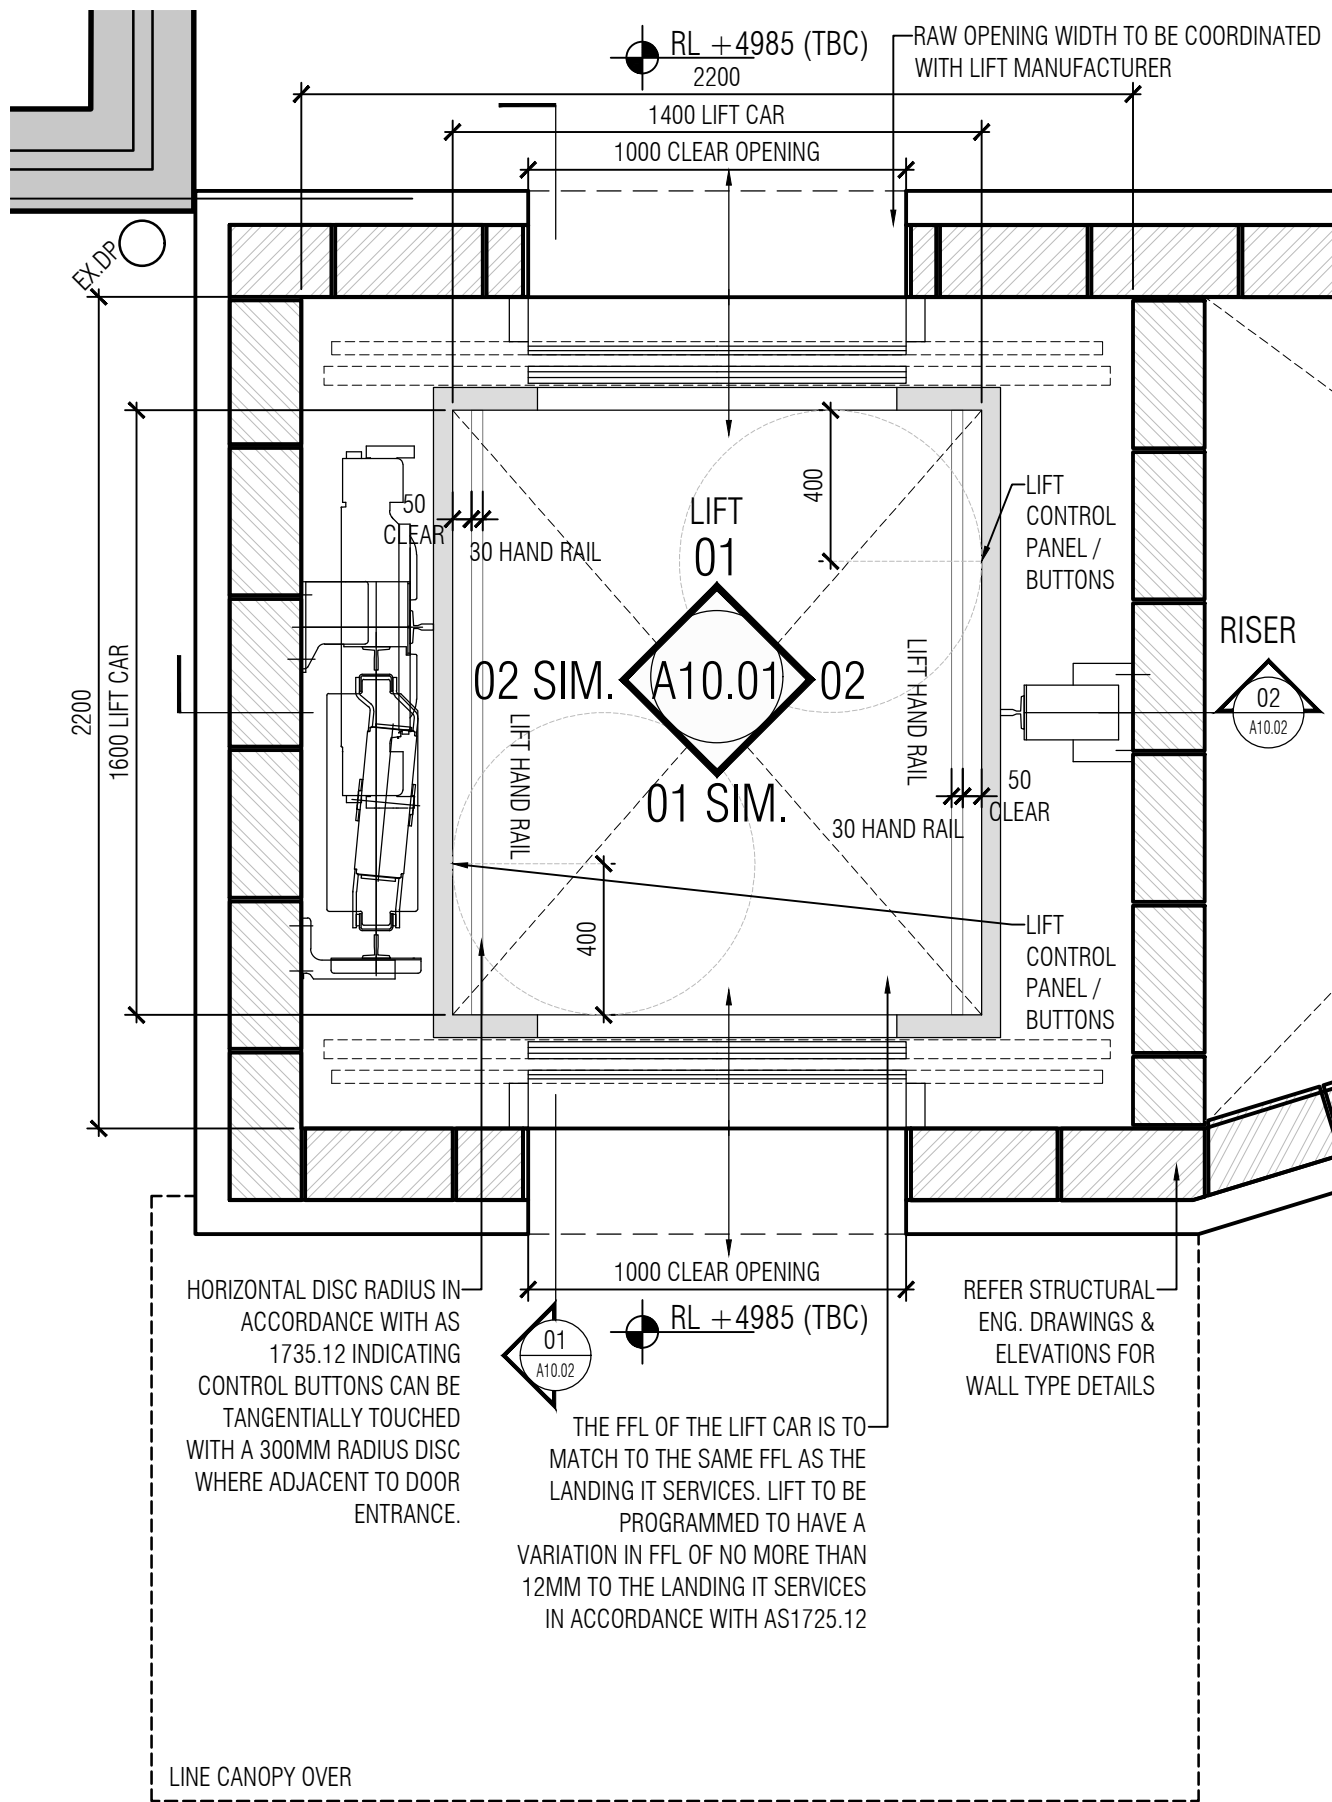

01 GROUND FLOOR (L1) PLAN VIEW
1:20@A3

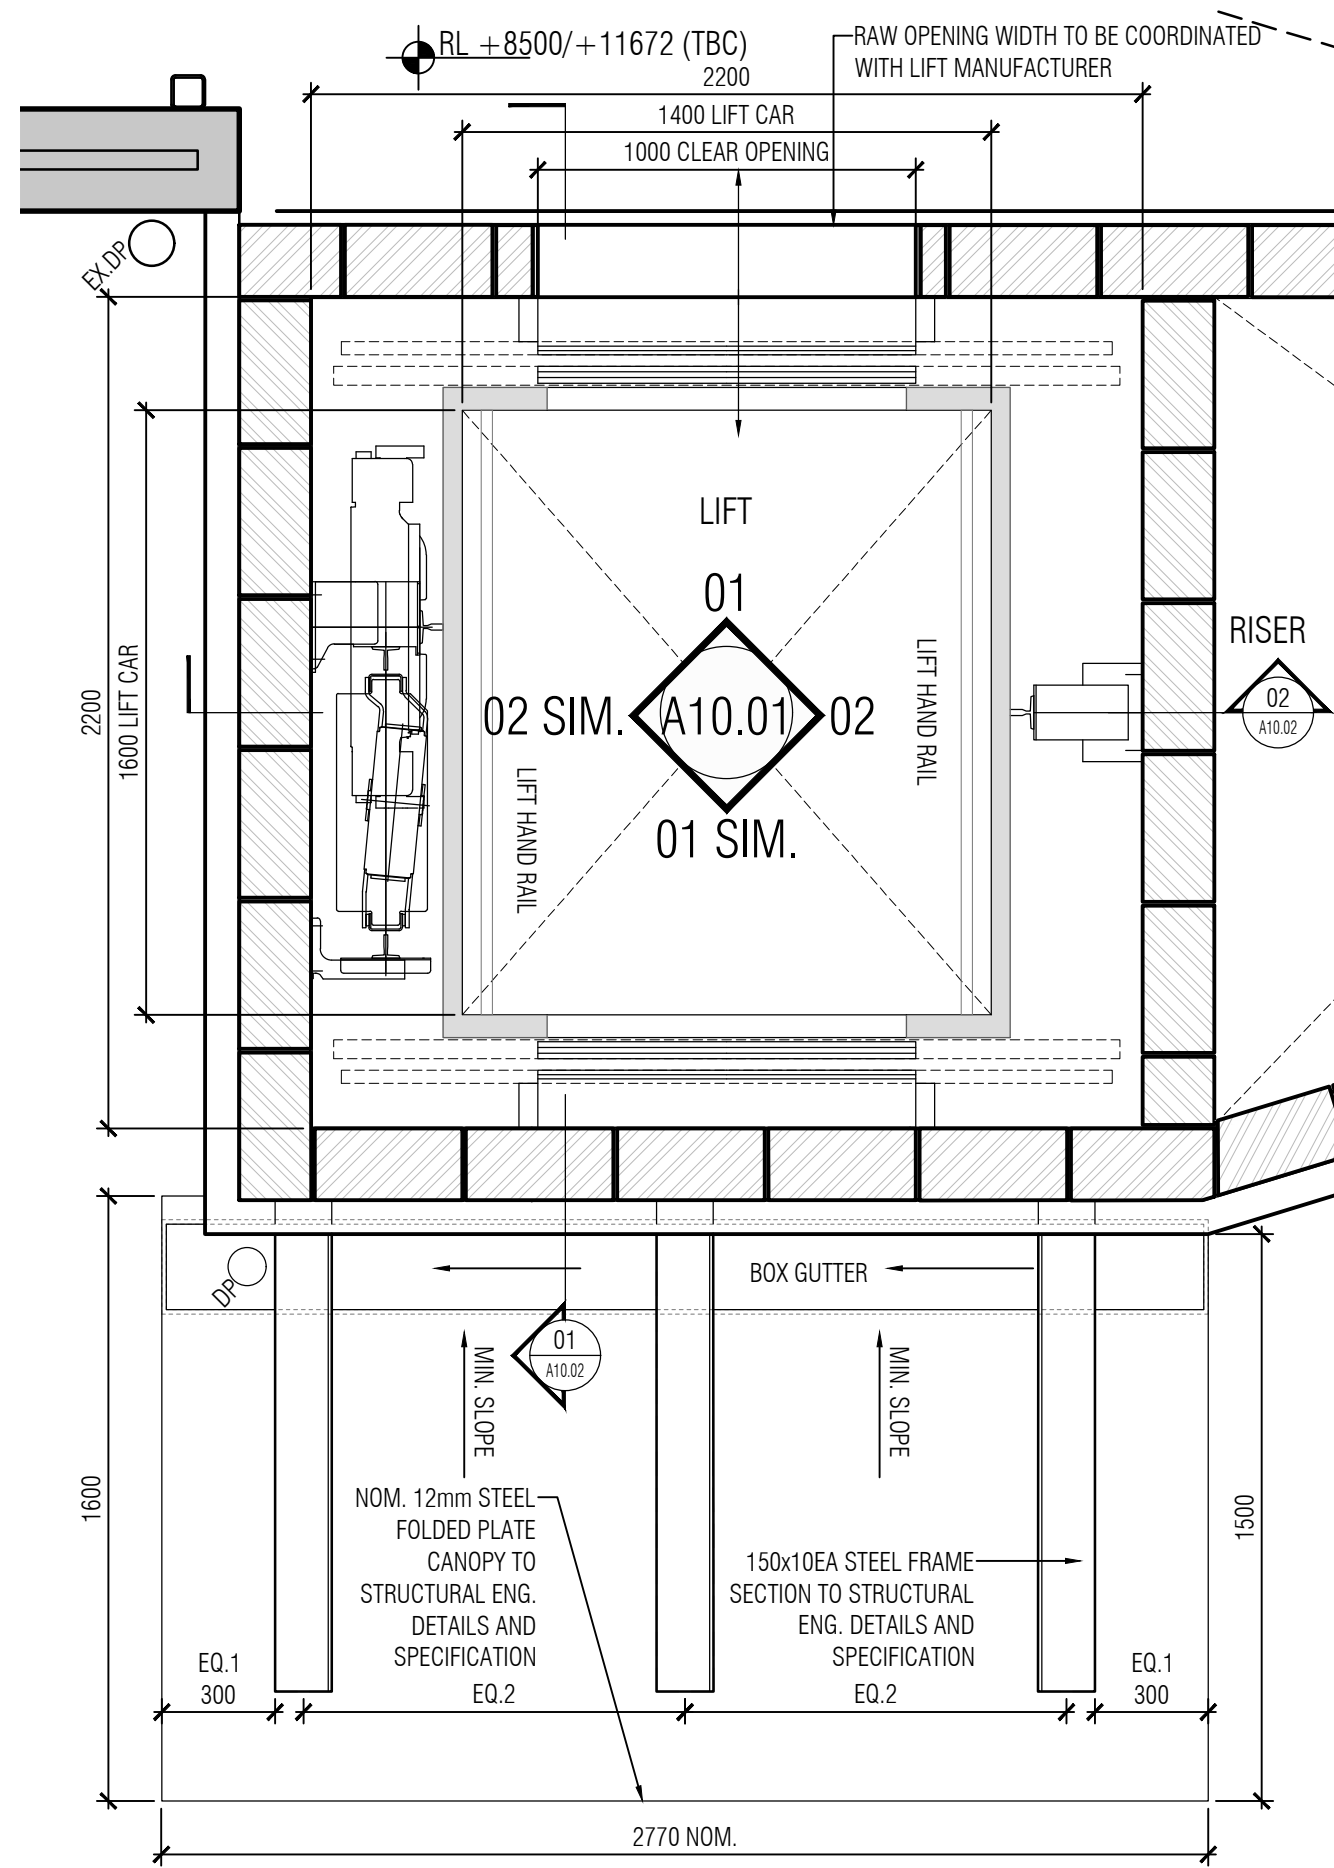

02 TYPICAL L2 & L3 PLAN VIEW
1:20@A3

ALL DIMENSIONS AND LEVELS TO BE VERIFIED ON SITE BY THE BUILDER BEFORE THE COMMENCEMENT OF ANY WORK. ANY DISCREPANCIES MUST BE REPORTED TO THE ARCHITECT IMMEDIATELY. DO NOT SCALE DRAWINGS. FIGURED DIMENSIONS HAVE PREFERENCE OVER DIMENSIONS SCALED FROM THE DRAWINGS. THESE DRAWINGS TO BE READ IN CONJUNCTION WITH THE SPECIFICATIONS AND OTHER ASSOCIATED DOCUMENTS. REFER TO ENGINEERING SERVICES DRAWINGS FOR CONFIRMATION OF LOCATIONS AND HEIGHT OF FITTINGS, AIR DIFFUSERS, GRILLES, SPRINKLERS, SMOKE DETECTORS, AND ALL OTHER CEILING MOUNTED OR RECESSED SERVICE OUTLETS AND FITTINGS AND ADDITIONAL SET OUT OF CEILING SUPPORT MEMBERS. MAKE ALL PENETRATIONS, CUT OUTS AND TRIM TO SUIT ALL RELEVANT SERVICE OUTLETS AND FITTINGS. ANY DISCREPANCIES BETWEEN THE ARCHITECTURAL AND SERVICES DOCUMENTS ARE TO BE REPORTED TO THE ARCHITECT FOR CLARIFICATION. IN THE EVENT OF DISCREPANCIES, THE CONTRACTOR MUST ALLOW FOR THE HIGHER COST ALTERNATIVE IN THE SCOPE OF WORKS. NOM INDICATES A NOMINAL DIMENSION TO BE CHECKED ON SITE.

REV	DESCRIPTION	DRAWN	DATE
1	PRELIMINARY	H2o	10.05.2024
2	FOR HERITAGE PERMIT	H2o	10.05.2024

CLIENT



VICTORIAN COLLEGE OF THE ARTS
The University of Melbourne

SERVICES ENGINEERING
Caleb Engineers
206 / 7 Jelfcott St,
West Melbourne, VIC 3003.
Ph. 9020 9347

BUILDING SURVEYOR
Wilmore Nelson McDermott
Suite 105/80 Monash Dr,
Dandenong South, VIC 3175.
Ph. 1300 799 543

STRUCTURAL ENGINEERING
Engineering Folk
0413 516 870

COST CONSULTANT


H2o architects Pty Ltd
29 Northumberland Street
Collingwood
Victoria 3066 Australia
T 61 3 9417 0900
F 61 3 9417 0911
studio@h2oarchitects.com.au

PROJECT
**UNIVERSITY OF MELBOURNE
BLDG 864 - PERFORMING ARTS**

DRAWING TITLE
PROPOSED LIFT DETAILS

DRAWN BY
H2o

PROJECT NUMBER
2356




SCALE
1:20 @ A3

PLOT DATE
10.05.2024

FOR HERITAGE PERMIT

DRAWING NUMBER
A10.00

REVISION
02

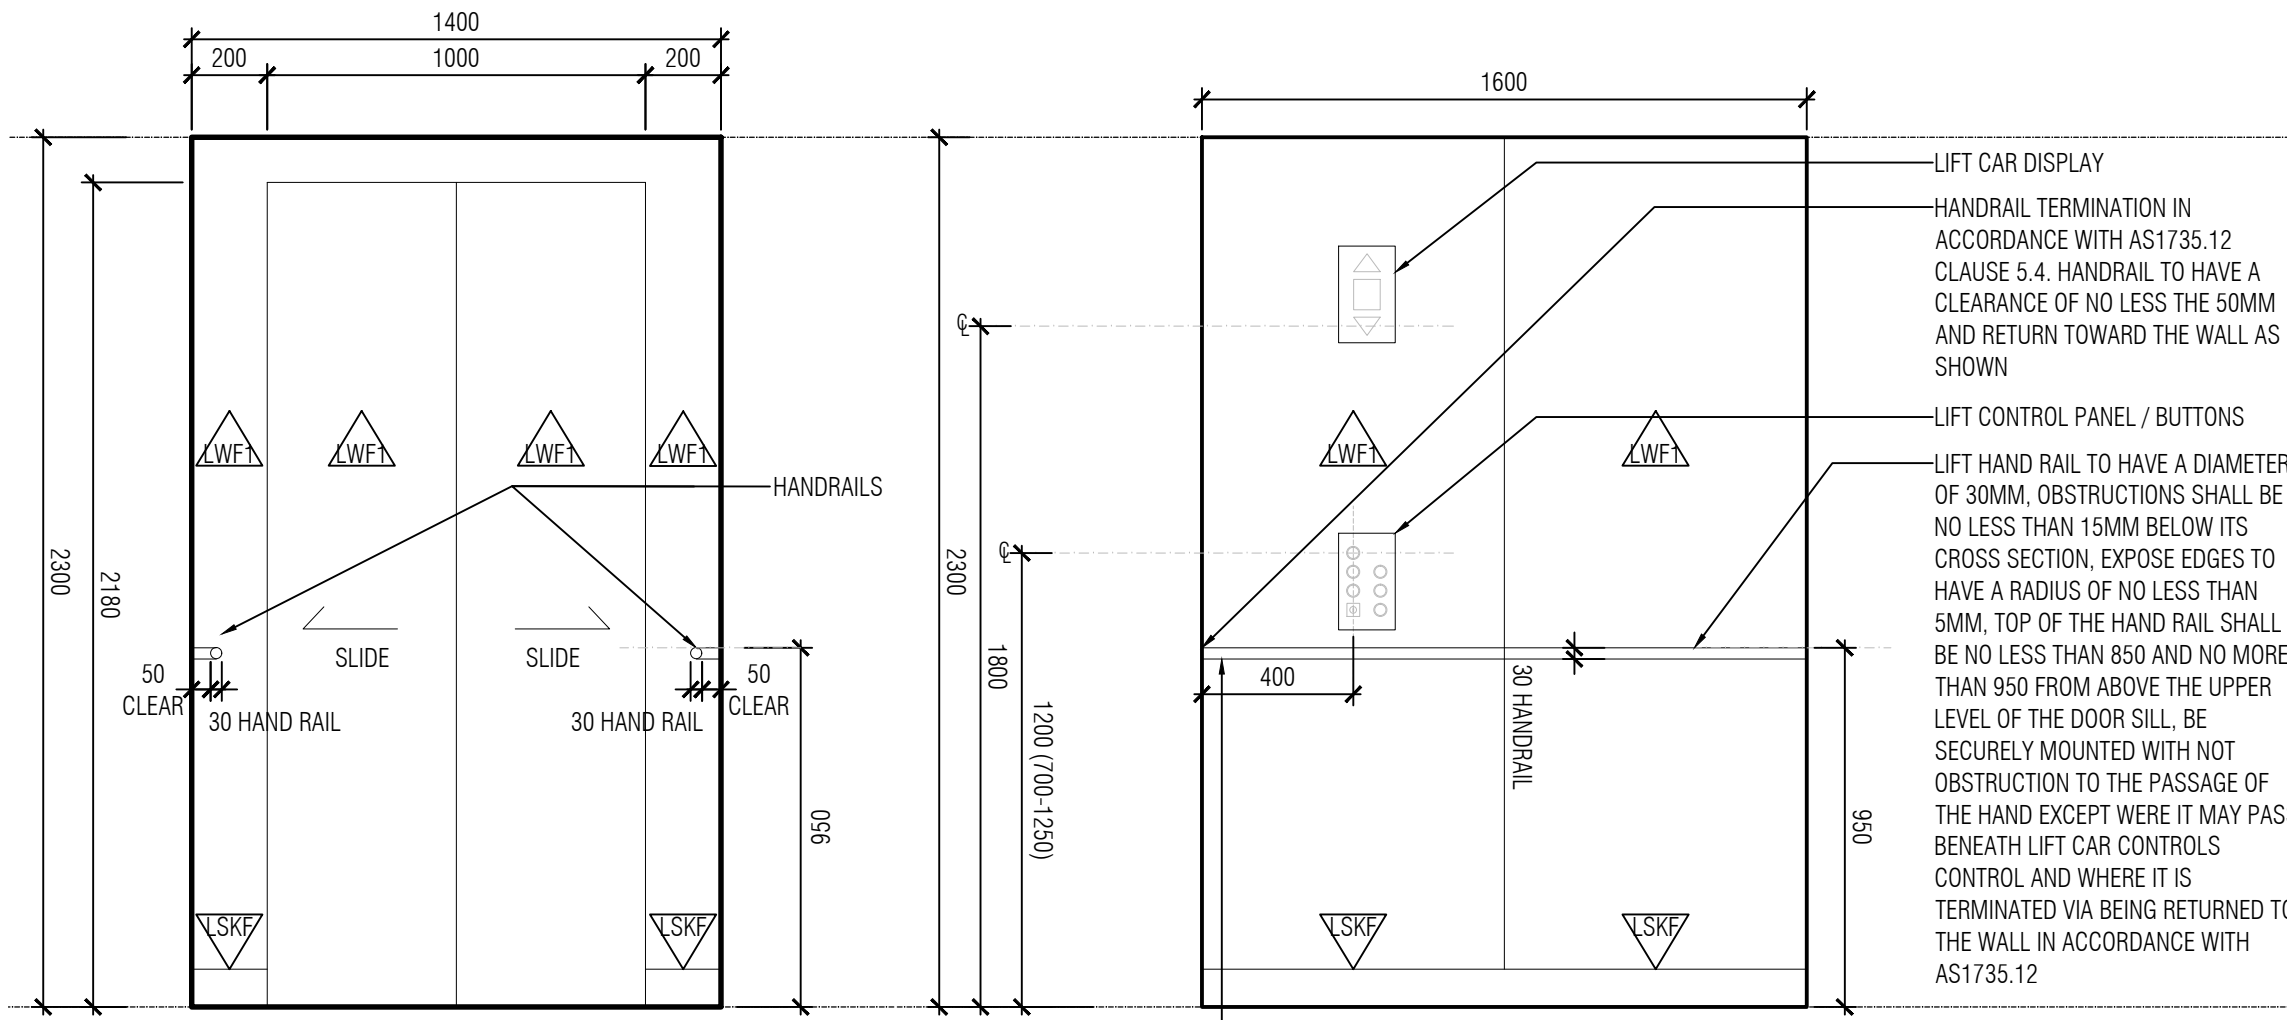

LIFT CAR DISPLAY


HANDRAIL TERMINATION IN ACCORDANCE WITH AS1735.12 CLAUSE 5.4. HANDRAIL TO HAVE A CLEARANCE OF NO LESS THE 50MM AND RETURN TOWARD THE WALL AS SHOWN

LIFT CONTROL PANEL / BUTTONS

LIFT HAND RAIL TO HAVE A DIAMETER OF 30MM, OBSTRUCTIONS SHALL BE NO LESS THAN 15MM BELOW ITS CROSS SECTION, EXPOSE EDGES TO HAVE A RADIUS OF NO LESS THAN 5MM, TOP OF THE HAND RAIL SHALL BE NO LESS THAN 850 AND NO MORE THAN 950 FROM ABOVE THE UPPER LEVEL OF THE DOOR SILL, BE SECURELY MOUNTED WITH NOT OBSTRUCTION TO THE PASSAGE OF THE HAND EXCEPT WERE IT MAY PASS BENEATH LIFT CAR CONTROLS CONTROL AND WHERE IT IS TERMINATED VIA BEING RETURNED TO THE WALL IN ACCORDANCE WITH AS1735.12

01 LIFT INTERNAL ELEVATION
1:20@A3

02 LIFT INTERNAL ELEVATION
1:20@A3

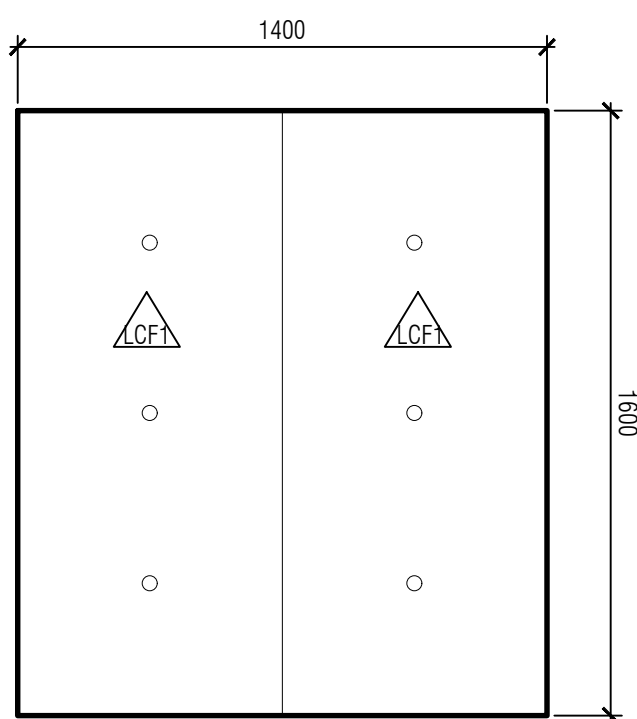

03 LIFT REFLECTED CEILING PLAN
1:20@A3

ALL DIMENSIONS AND LEVELS TO BE VERIFIED ON SITE BY THE BUILDER BEFORE THE COMMENCEMENT OF ANY WORK. ANY DISCREPANCIES MUST BE REPORTED TO THE ARCHITECT IMMEDIATELY. DO NOT SCALE DRAWINGS. FIGURED DIMENSIONS HAVE PREFERENCE OVER DIMENSIONS SCALED FROM THE DRAWINGS. THESE DRAWINGS TO BE READ IN CONJUNCTION WITH THE SPECIFICATIONS AND OTHER ASSOCIATED DOCUMENTS. REFER TO ENGINEERING SERVICES DRAWINGS FOR CONFIRMATION OF LOCATIONS AND HEIGHT OF FITTINGS, AIR DIFFUSERS, GRILLES, SPRINKLERS, SMOKE DETECTORS, AND ALL OTHER CEILING MOUNTED OR RECESSED SERVICE OUTLETS AND FITTINGS AND ADDITIONAL SET OUT OF CEILING SUPPORT MEMBERS. MAKE ALL PENETRATIONS, CUT OUTS AND TRIM TO SUIT ALL RELEVANT SERVICE OUTLETS AND FITTINGS. ANY DISCREPANCIES BETWEEN THE ARCHITECTURAL AND SERVICES DOCUMENTS ARE TO BE REPORTED TO THE ARCHITECT FOR CLARIFICATION. IN THE EVENT OF DISCREPANCIES, THE CONTRACTOR MUST ALLOW FOR THE HIGHER COST ALTERNATIVE IN THE SCOPE OF WORKS. NOM INDICATES A NOMINAL DIMENSION TO BE CHECKED ON SITE.

REV	DESCRIPTION	DRAWN	DATE
1	FOR HERITAGE PERMIT	H2o	10.05.2024
2	PRELIMINARY	H2o	10.05.2024

CLIENT

The University of Melbourne

SERVICES ENGINEERING
Caleb Engineers
206 / 7 Jelfcott St,
West Melbourne, VIC 3003.
Ph. 9020 9347

BUILDING SURVEYOR
Wilmore Nelson McDermott
Suite 105/80 Monash Dr,
Dandenong South, VIC 3175.
Ph. 1300 799 543

STRUCTURAL ENGINEERING
Engineering Folk
0413 516 870

COST CONSULTANT

H2o architects Pty Ltd
29 Northumberland Street
Collingwood
Victoria 3066 Australia
T 61 3 9417 0900
F 61 3 9417 0911
studio@h2oarchitects.com.au

PROJECT
**UNIVERSITY OF MELBOURNE
BLDG 864 - PERFORMING ARTS**

DRAWING TITLE
PROPOSED LIFT DETAILS

DRAWN BY
H2o

PROJECT NUMBER
2356


SCALE
1:20 @ A3

PLOT DATE
10.05.2024


FOR HERITAGE PERMIT

DRAWING NUMBER
A10.01

REVISION
2

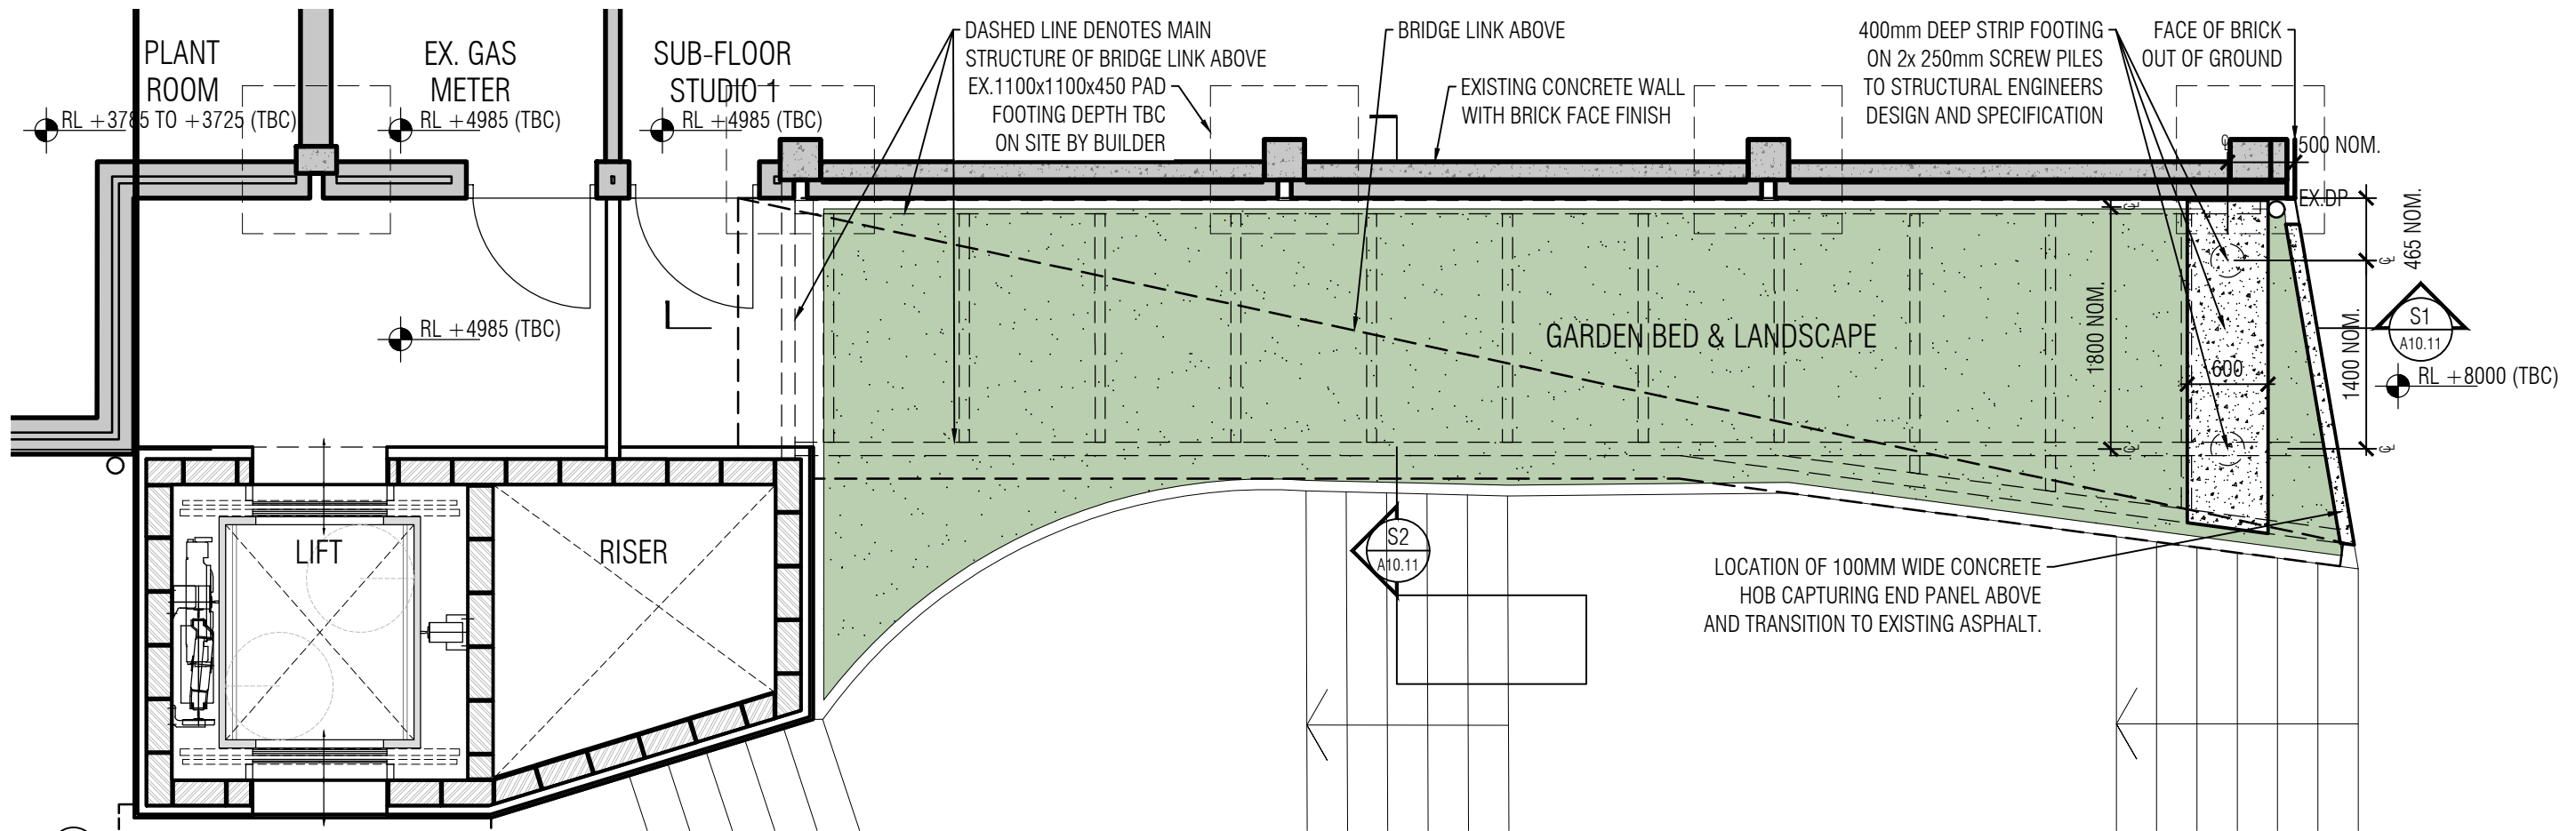

01 PLAN DETAIL
BRIDGE LINK L01
1:50@A3

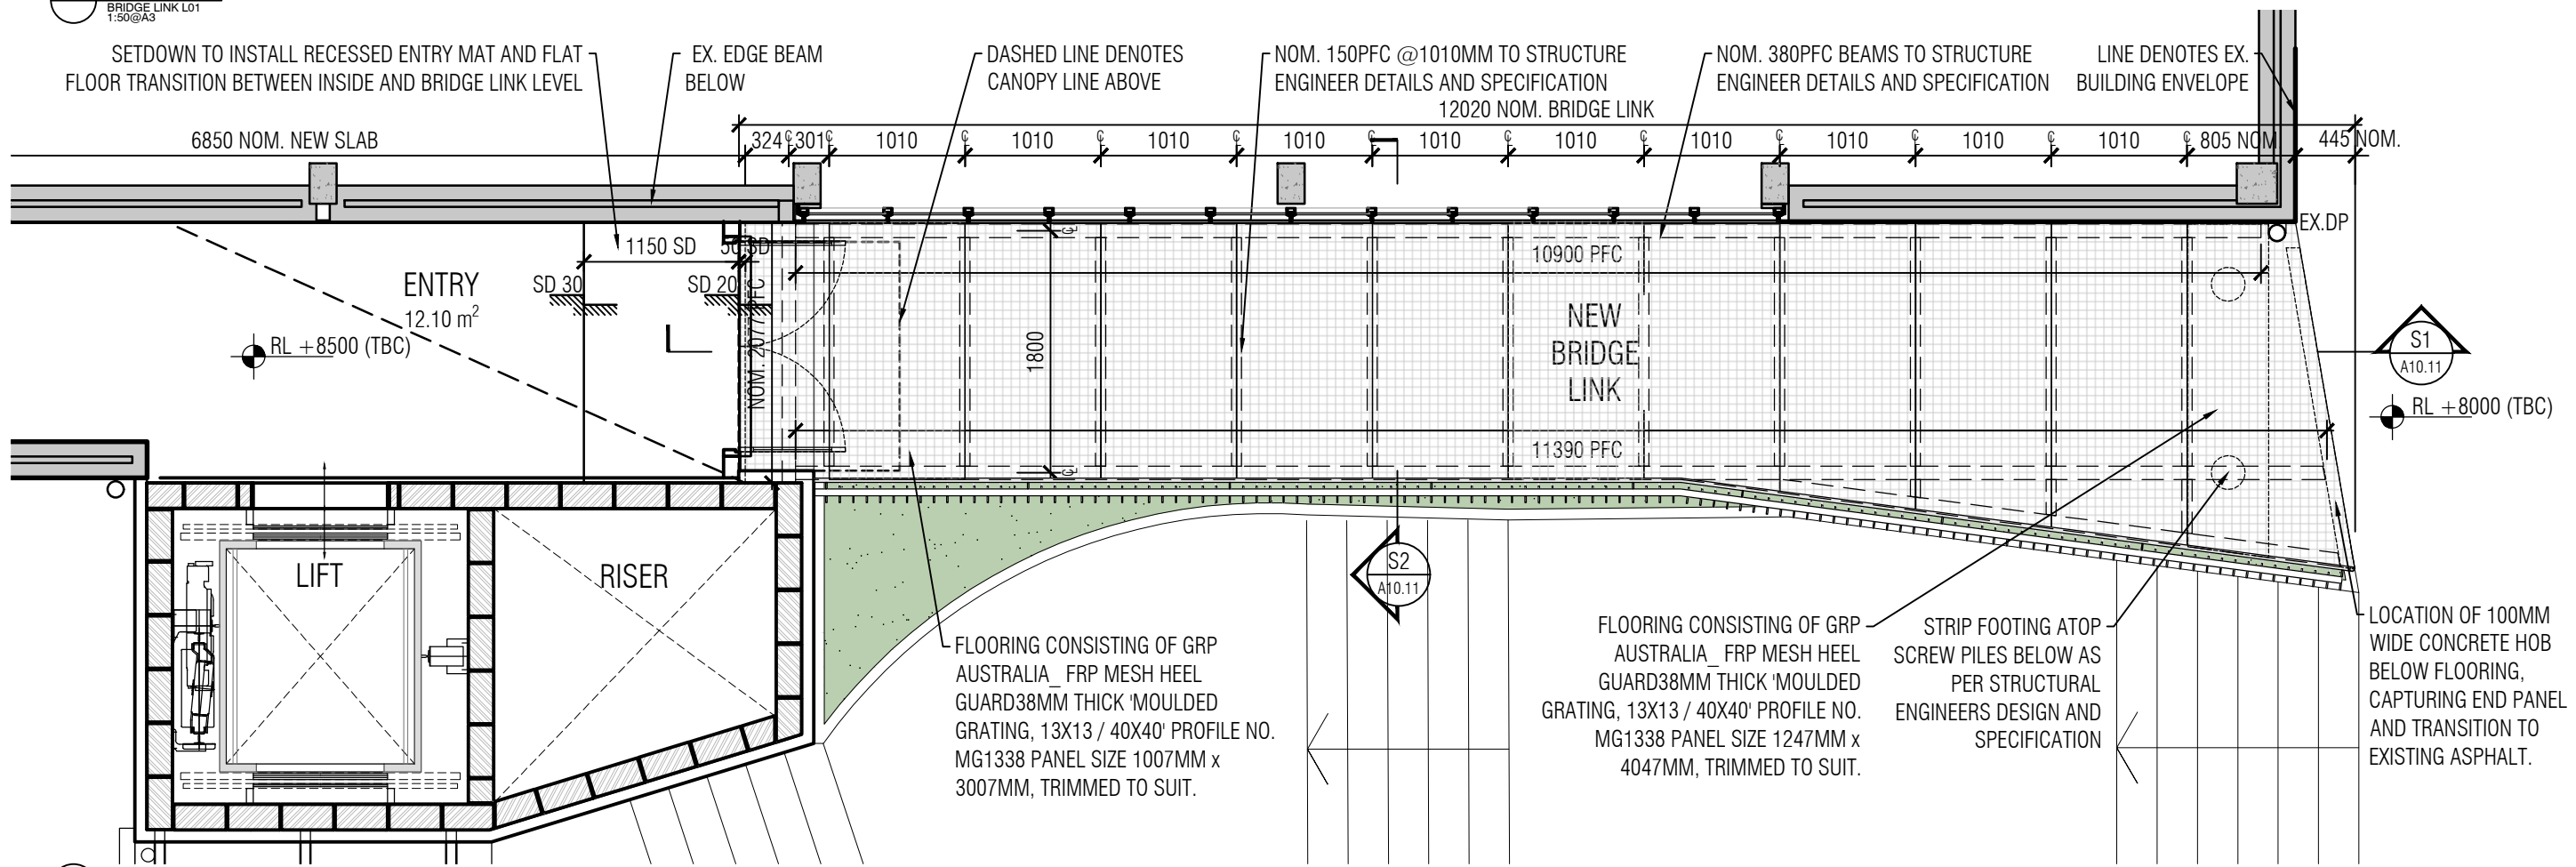

02 PLAN DETAIL
BRIDGE LINK L02
1:50@A3

ALL DIMENSIONS AND LEVELS TO BE VERIFIED ON SITE BY THE BUILDER BEFORE THE COMMENCEMENT OF ANY WORK. ANY DISCREPANCIES MUST BE REPORTED TO THE ARCHITECT IMMEDIATELY. DO NOT SCALE DRAWINGS. FIGURED DIMENSIONS HAVE PREFERENCE OVER DIMENSIONS SCALED FROM THE DRAWINGS. THESE DRAWINGS TO BE READ IN CONJUNCTION WITH THE SPECIFICATIONS AND OTHER ASSOCIATED DOCUMENTS. REFER TO ENGINEERING SERVICES DRAWINGS FOR CONFIRMATION OF LOCATIONS AND HEIGHT OF FITTINGS, AIR DIFFUSERS, GRILLES, SPRINKLERS, SMOKE DETECTORS, AND ALL OTHER CEILING MOUNTED OR RECESSED SERVICE OUTLETS AND FITTINGS AND ADDITIONAL SET OUT OF CEILING SUPPORT MEMBERS. MAKE ALL PENETRATIONS, CUT OUTS AND TRIM TO SUIT ALL RELEVANT SERVICE OUTLETS AND FITTINGS. ANY DISCREPANCIES BETWEEN THE ARCHITECTURAL AND SERVICES DOCUMENTS ARE TO BE REPORTED TO THE ARCHITECT FOR CLARIFICATION. IN THE EVENT OF DISCREPANCIES, THE CONTRACTOR MUST ALLOW FOR THE HIGHER COST ALTERNATIVE IN THE SCOPE OF WORKS. NOM INDICATES A NOMINAL DIMENSION TO BE CHECKED ON SITE.

REV	DESCRIPTION	DRAWN	DATE	CLIENT
1	FOR HERITAGE PERMIT		10.05.2024	



SERVICES ENGINEERING
Caleb Engineers
206 / 7 Jelfcott St,
West Melbourne, VIC 3003.
Ph. 9020 9347

BUILDING SURVEYOR
Wilmore Nelson McDermott
Suite 105/80 Monash Dr,
Dandenong South, VIC 3175.
Ph. 1300 799 543

STRUCTURAL ENGINEERING
Engineering Folk
0413 516 870

COST CONSULTANT

H2o architects Pty Ltd
29 Northumberland Street
Collingwood
Victoria 3066 Australia
T 61 3 9417 0900
F 61 3 9417 0911
studio@h2oarchitects.com.au

PROJECT
**UNIVERSITY OF MELBOURNE
BLDG 864 - PERFORMING ARTS**

DRAWING TITLE
PROPOSED BRIDGE LINK DETAILS

DRAWN BY
H2o

PROJECT NUMBER
2356

SCALE
1:50 @ A3

PLOT DATE
10.05.2024

FOR HERITAGE PERMIT

DRAWING NUMBER
A10.10

REVISION
1



1 EXISTING BRIDGE VIEW
NTS

ALL DIMENSIONS AND LEVELS TO BE VERIFIED ON SITE BY THE BUILDER BEFORE THE COMMENCEMENT OF ANY WORK. ANY DISCREPANCIES MUST BE REPORTED TO THE ARCHITECT IMMEDIATELY. DO NOT SCALE DRAWINGS. FIGURED DIMENSIONS HAVE PREFERENCE OVER DIMENSIONS SCALED FROM THE DRAWINGS. THESE DRAWINGS TO BE READ IN CONJUNCTION WITH THE SPECIFICATIONS AND OTHER ASSOCIATED DOCUMENTS. REFER TO ENGINEERING SERVICES DRAWINGS FOR CONFIRMATION OF LOCATIONS AND HEIGHT OF FITTINGS, AIR DIFFUSERS, GRILLES, SPRINKLERS, SMOKE DETECTORS, AND ALL OTHER CEILING MOUNTED OR RECESSED SERVICE OUTLETS AND FITTINGS AND ADDITIONAL SET OUT OF CEILING SUPPORT MEMBERS. MAKE ALL PENETRATIONS, CUT OUTS AND TRIM TO SUIT ALL RELEVANT SERVICE OUTLETS AND FITTINGS. ANY DISCREPANCIES BETWEEN THE ARCHITECTURAL AND SERVICES DOCUMENTS ARE TO BE REPORTED TO THE ARCHITECT FOR CLARIFICATION. IN THE EVENT OF DISCREPANCIES, THE CONTRACTOR MUST ALLOW FOR THE HIGHER COST ALTERNATIVE IN THE SCOPE OF WORKS. NOM INDICATES A NOMINAL DIMENSION TO BE CHECKED ON SITE.

REV	DESCRIPTION	DRAWN	DATE
1	FOR HERITAGE PERMIT		10.05.2024

CLIENT



VICTORIAN COLLEGE OF THE ARTS
The University of Melbourne

SERVICES ENGINEERING
Caleb Engineers
206 / 7 Jelfcott St,
West Melbourne, VIC 3003.
Ph. 9020 9347

BUILDING SURVEYOR
Wilmore Nelson McDermott
Suite 105/80 Monash Dr,
Dandenong South, VIC 3175.
Ph. 1300 799 543

STRUCTURAL ENGINEERING
Engineering Folk
0413 516 870

COST CONSULTANT


H2o architects Pty Ltd
29 Northumberland Street
Collingwood
Victoria 3066 Australia
T 61 3 9417 0900
F 61 3 9417 0911
studio@h2oarchitects.com.au

PROJECT
**UNIVERSITY OF MELBOURNE
BLDG 864 - PERFORMING ARTS**

DRAWING TITLE
**EXISTING IMAGE
BEFORE BRIDGE WALKWAY**

DRAWN BY
H2o

PROJECT NUMBER
2356



SCALE
NTS

PLOT DATE
10.05.2024

FOR HERITAGE PERMIT

DRAWING NUMBER
A20.00

REVISION
1



1 PROPOSED BRIDGE VIEW
NTS

ALL DIMENSIONS AND LEVELS TO BE VERIFIED ON SITE BY THE BUILDER BEFORE THE COMMENCEMENT OF ANY WORK. ANY DISCREPANCIES MUST BE REPORTED TO THE ARCHITECT IMMEDIATELY. DO NOT SCALE DRAWINGS. FIGURED DIMENSIONS HAVE PREFERENCE OVER DIMENSIONS SCALED FROM THE DRAWINGS. THESE DRAWINGS TO BE READ IN CONJUNCTION WITH THE SPECIFICATIONS AND OTHER ASSOCIATED DOCUMENTS. REFER TO ENGINEERING SERVICES DRAWINGS FOR CONFIRMATION OF LOCATIONS AND HEIGHT OF FITTINGS, AIR DIFFUSERS, GRILLES, SPRINKLERS, SMOKE DETECTORS, AND ALL OTHER CEILING MOUNTED OR RECESSED SERVICE OUTLETS AND FITTINGS AND ADDITIONAL SET OUT OF CEILING SUPPORT MEMBERS. MAKE ALL PENETRATIONS, CUT OUTS AND TRIM TO SUIT ALL RELEVANT SERVICE OUTLETS AND FITTINGS. ANY DISCREPANCIES BETWEEN THE ARCHITECTURAL AND SERVICES DOCUMENTS ARE TO BE REPORTED TO THE ARCHITECT FOR CLARIFICATION. IN THE EVENT OF DISCREPANCIES, THE CONTRACTOR MUST ALLOW FOR THE HIGHER COST ALTERNATIVE IN THE SCOPE OF WORKS. NOM INDICATES A NOMINAL DIMENSION TO BE CHECKED ON SITE.

REV	DESCRIPTION	DRAWN DATE	CLIENT
1	FOR HERITAGE PERMIT	10.05.2024	


VICTORIAN COLLEGE OF THE ARTS
 The University of Melbourne

SERVICES ENGINEERING
 Caleb Engineers
 206 / 7 Jellicott St,
 West Melbourne, VIC 3003.
 Ph. 9020 9347

BUILDING SURVEYOR
 Wilmore Nelson McDermott
 Suite 105/80 Monash Dr,
 Dandenong South, VIC 3175.
 Ph. 1300 799 543

STRUCTURAL ENGINEERING
 Engineering Folk
 0413 516 870

COST CONSULTANT

H2o architects Pty Ltd
 29 Northumberland Street
 Collingwood
 Victoria 3066 Australia
 T 61 3 9417 0900
 F 61 3 9417 0911
 studio@h2oarchitects.com.au




PROJECT
 UNIVERSITY OF MELBOURNE
 BLDG 864 - PERFORMING ARTS

DRAWING TITLE
 PROPOSED BRIDGE WALKWAY

DRAWN BY
 H2o

PROJECT NUMBER
 2356



SCALE	PLOT DATE
NTS	10.05.2024
FOR HERITAGE PERMIT	
DRAWING NUMBER	REVISION
A20.01	1



1 PROPOSED MATERIAL BOARD
NTS

ALL DIMENSIONS AND LEVELS TO BE VERIFIED ON SITE BY THE BUILDER BEFORE THE COMMENCEMENT OF ANY WORK. ANY DISCREPANCIES MUST BE REPORTED TO THE ARCHITECT IMMEDIATELY. DO NOT SCALE DRAWINGS. FIGURED DIMENSIONS HAVE PREFERENCE OVER DIMENSIONS SCALED FROM THE DRAWINGS. THESE DRAWINGS TO BE READ IN CONJUNCTION WITH THE SPECIFICATIONS AND OTHER ASSOCIATED DOCUMENTS. REFER TO ENGINEERING SERVICES DRAWINGS FOR CONFIRMATION OF LOCATIONS AND HEIGHT OF FITTINGS, AIR DIFFUSERS, GRILLES, SPRINKLERS, SMOKE DETECTORS, AND ALL OTHER CEILING MOUNTED OR RECESSED SERVICE OUTLETS AND FITTINGS AND ADDITIONAL SET OUT OF CEILING SUPPORT MEMBERS. MAKE ALL PENETRATIONS, CUT OUTS AND TRIM TO SUIT ALL RELEVANT SERVICE OUTLETS AND FITTINGS. ANY DISCREPANCIES BETWEEN THE ARCHITECTURAL AND SERVICES DOCUMENTS ARE TO BE REPORTED TO THE ARCHITECT FOR CLARIFICATION. IN THE EVENT OF DISCREPANCIES, THE CONTRACTOR MUST ALLOW FOR THE HIGHER COST ALTERNATIVE IN THE SCOPE OF WORKS. NOM INDICATES A NOMINAL DIMENSION TO BE CHECKED ON SITE.

REV	DESCRIPTION	DRAWN	DATE
1	FOR HERITAGE PERMIT	-	10.05.2024

CLIENT



VICTORIAN COLLEGE OF THE ARTS
The University of Melbourne

SERVICES ENGINEERING
Caleb Engineers
206 / 7 Jellicott St,
West Melbourne, VIC 3003.
Ph. 9020 9347

BUILDING SURVEYOR
Wilmore Nelson McDermott
Suite 105/80 Monash Dr,
Dandenong South, VIC 3175.
Ph. 1300 799 543

STRUCTURAL ENGINEERING
Engineering Folk
0413 516 870

COST CONSULTANT


H2o architects Pty Ltd
29 Northumberland Street
Collingwood
Victoria 3066 Australia
T 61 3 9417 0900
F 61 3 9417 0911
studio@h2oarchitects.com.au

PROJECT
**UNIVERSITY OF MELBOURNE
BLDG 864 - PERFORMING ARTS**

DRAWING TITLE
PROPOSED EXTERIOR MATERIALS

DRAWN BY
H2o

PROJECT NUMBER
2356




SCALE
NTS

PLOT DATE
10.05.2024

FOR HERITAGE PERMIT

DRAWING NUMBER
A20.02

REVISION
1

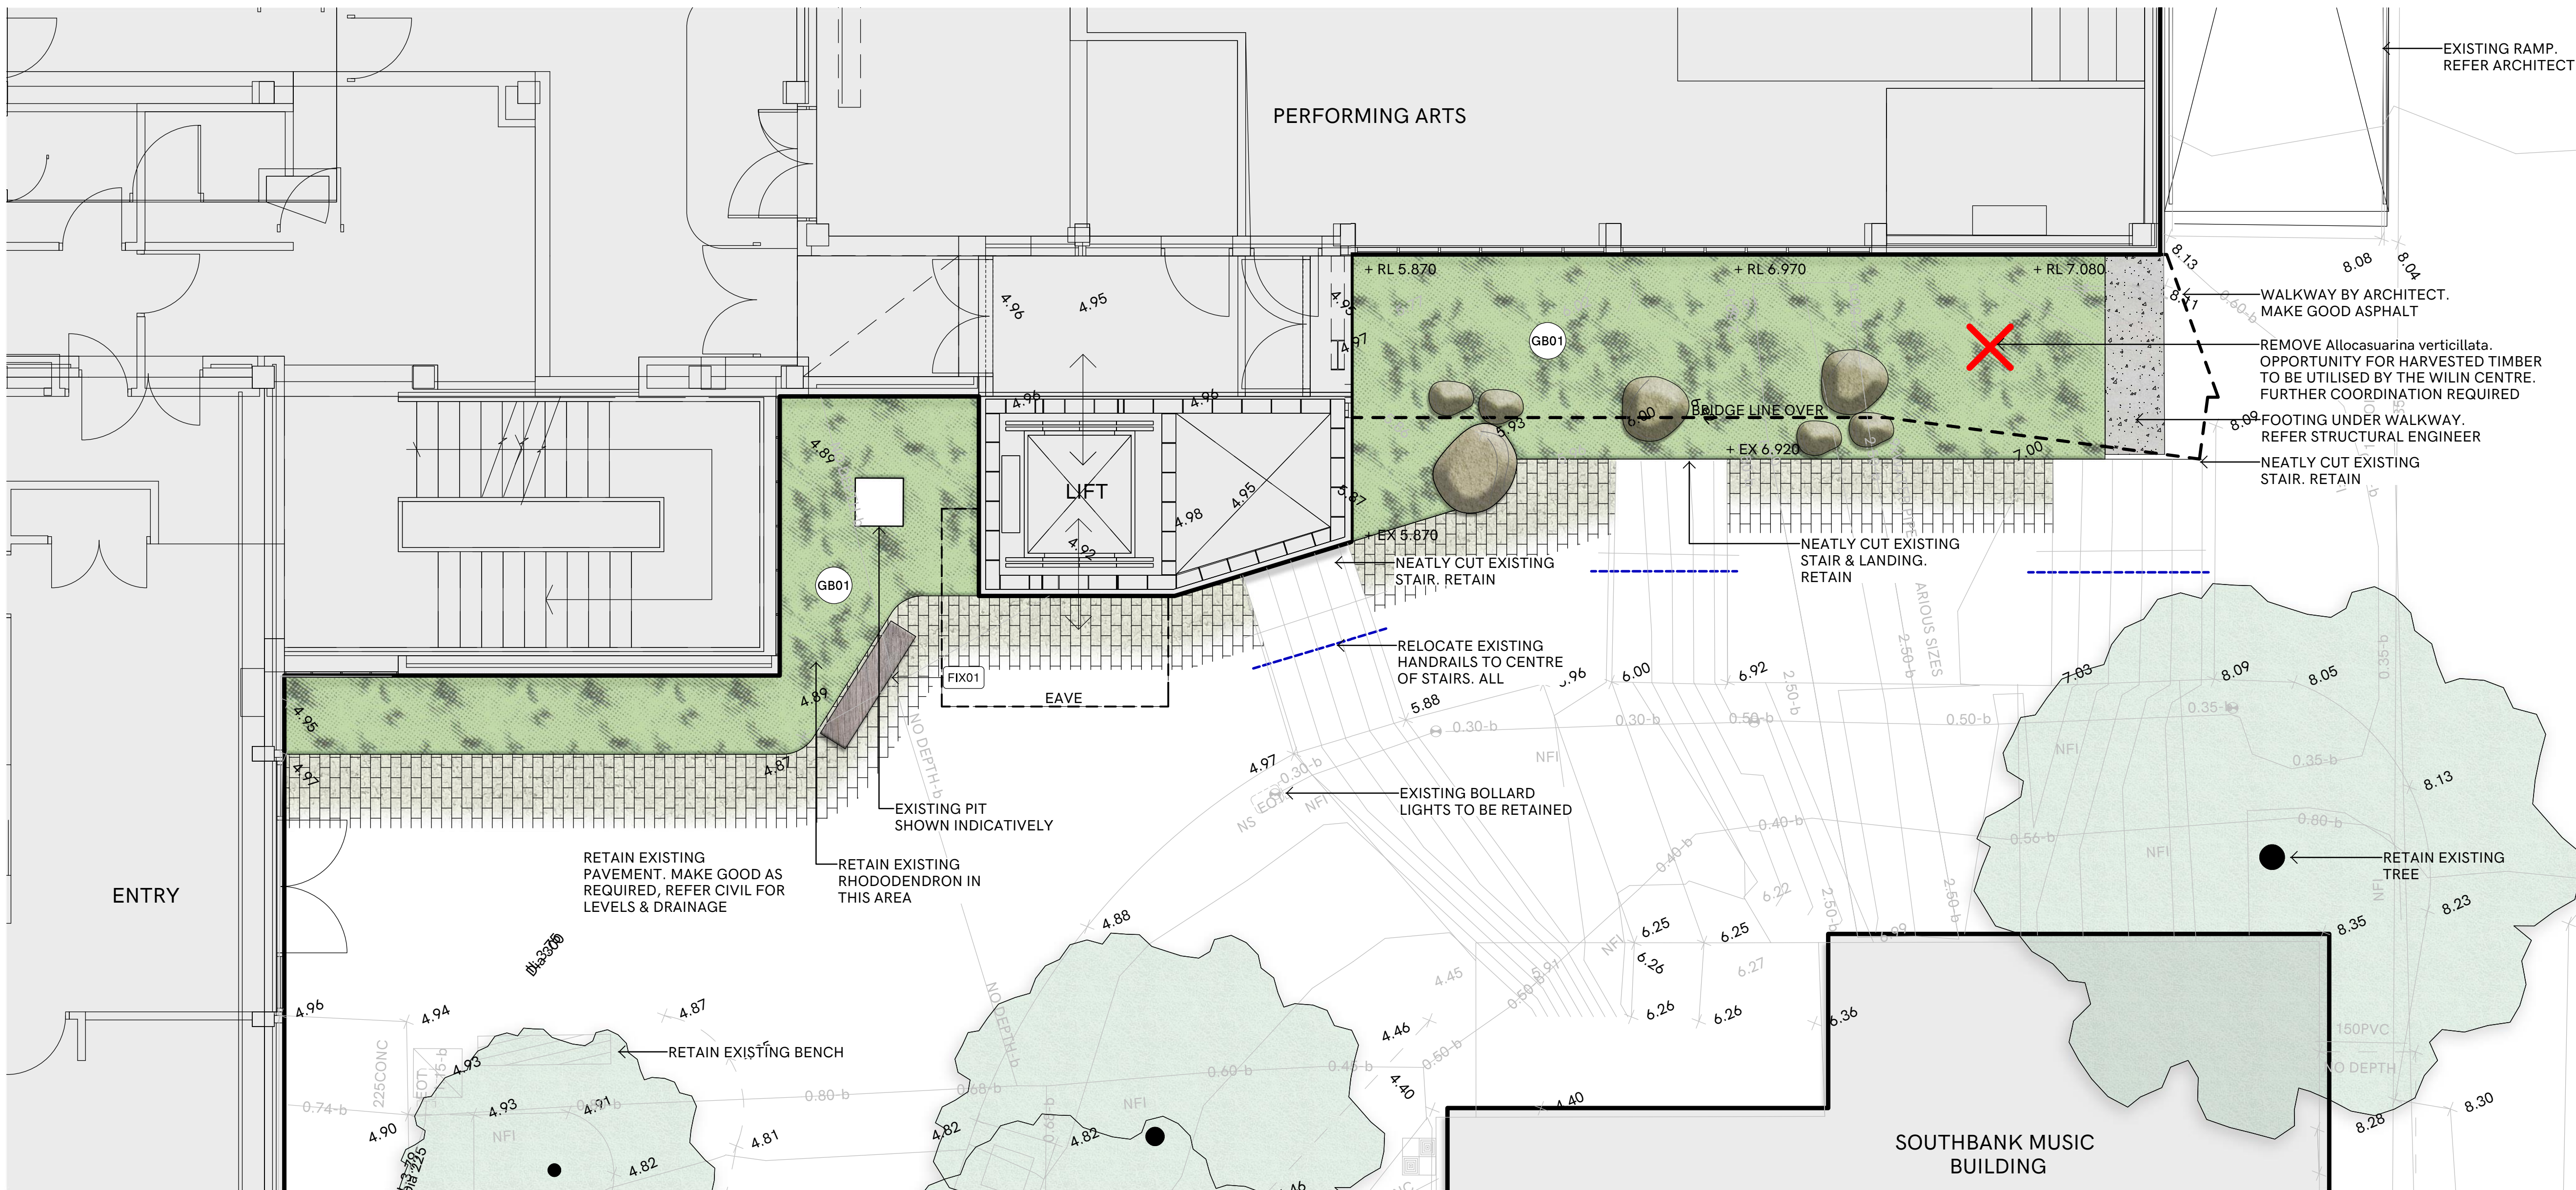

- SITE PREPARATION & SOFT LANDSCAPE**
- PROJECT BOUNDARY
 - EXISTING TREE TO BE RETAINED
 - EXISTING TREE TO BE REMOVED
 - PROPOSED TREE
 - TREE PROTECTION ZONE
 - AGI DRAIN TO GARDEN BEDS
- SOFT LANDSCAPE**
- GARDEN BED
 - HARDWOOD HABITAT LOG
 - STONE BOULDER
- PAVING**
- BRICK PAVERS - PEDESTRIAN GRADE
- EDGES**
- FLUSH BRICK EDGE
 - STEEL EDGE
- FIXTURES**
- BENCH SEAT

PLANT SCHEDULE

CODE	BOTANICAL NAME
Shrubs	
Cost	Cordyline stricta
Inau	Indigofera australis
Olli	Olearia lirata
Herbaceous & Flowering Plants	
Alnu	Alpinia nutans
Asau	Asplenium australasicum
Dian	Dicksonia antarctica
Pttr	Pteris tremula
Grasses	
DitaE	Dianella tasmanica 'Emerald Arch'
Groundcovers	
Dire	Dichondra repens
Vihe	Viola hederacea

PLANT IMAGES

Ferns, Herbaceous & Flowering Plants



Code: Alnu
 Botanical Name: Alpinia nutans
 Common Name: Dwarf Cardamon Ginger
 Size: Height 2.0M x Spread 1.0M



Code: Dian
 Botanical Name: Dicksonia antarctica
 Common Name: Soft Tree Fern
 Size: Height 3.0M x Spread 2.0M



Code: Asau
 Botanical Name: Asplenium australasicum
 Common Name: Bird's Nest Fern
 Size: Height 1.0M x Spread 2.0M



Code: Pttr
 Botanical Name: Pteris tremula
 Common Name: Tender Brakefern
 Size: Height 0.6M x Spread 1.5M

Groundcovers



Code: Dire
 Botanical Name: Dichondra repens
 Common Name: Kidney Weed
 Size: Height 0.3M x Spread 1.0M



Code: Vihe
 Botanical Name: Viola hederacea
 Common Name: Native Violet
 Size: Height 0.2M x Spread 0.6M

Shrubs



Code: Cost
 Botanical Name: Cordyline stricta
 Common Name: Slender Palm Lily
 Size: Height 2.0M x Spread 1.0M




Code: Inau
 Botanical Name: Indigofera australis
 Common Name: Australian Indigo
 Size: Height 2.0M x Spread 1.5M

Grasses



Code: DitaE
 Botanical Name: Dianella tasmanica 'Emerald Arch'
 Common Name: Dianella Emerald Arch
 Size: Height 0.5M x Spread 0.5M

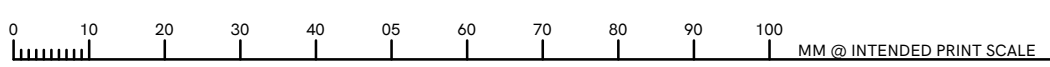

REV	DATE	DR	CH	COMMENT
P1	05/13/2024	MH	NS	DRAFT

THESE DRAWINGS ARE THE COPYRIGHT OF BUSH PROJECTS AND ARE NOT TO BE REPRODUCED WITHOUT WRITTEN APPROVAL. FIGURED DIMENSIONS TAKE PRECEDENCE OVER SCALED. IF REQUIRED REFER TO ARCHITECTS FOR FURTHER INFORMATION.

PRELIMINARY FOR CONSTRUCTION

PROJECT NAME UNIVERSITY OF MELBOURNE BLDG 846 - PERFORMING ARTS	DRAWN BY MH	PROJECT NUMBER 24008
CLIENT THE VICTORIAN COLLEGE OF THE ARTS	CHECKED BY NS	STAGE SK
ADDRESS 204-234 ST KILDA ROAD		DRAWING LA200
DRAWING TITLE LANDSCAPE PLAN	SHEET 2 of 3	SCALE 1:50 @ A1