
MOUNT ALEXANDER SHIRE COUNCIL VAUGHAN-TARILTA ROAD BRIDGE **DESIGN UPGRADE**

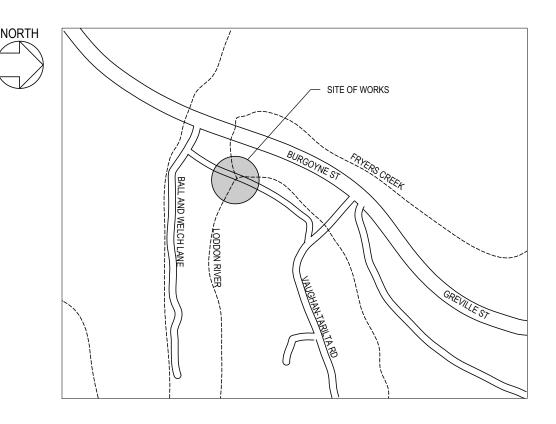

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CAUTION

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POSITION SHOULD BE PROVEN ON SITE. NO GUARANTEE
IS GIVEN THAT ALL EXISTING SERVICES ARE SHOWN



FOR TENDER NOT FOR CONSTRUCTION

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ł	A FOR APPRO		A.D.	M.A.	J.W.	31/05/2018			Shire Council
ŀ			A.D.	.ALTC	U.W.		DATE		Shire Council
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CLIENT MOUNT ALEXANDER SHIRE COUNC
VAUGHAN-TARILTA ROAD
BRIDGE

TITLE	
	COVER SHEET AND DRAWING LIST

		Aug. 4, 23 - 12:46:41 Name: P.23.0690-00-STR-DRG-S301.dwg Updated	By: Adrian Brunato
TATUS	FOR TENDER	DRAWING No. S-P.23.0690-00-STR-DRG-S301	REVISION B
	BRIDGE	AHD / MGA	CLIENT No.
(OULO)	VAUGHAN-TARILTA ROAD		

- 2. THE CONTRACTOR SHALL BE RESPONSIBLE FOR MAINTAINING THE STRUCTURE IN A STABLE CONDITION AND ENSURING NO PART BE OVERSTRESSED DURING CONSTRUCTION ACTIVITIES.
- 3. THE CONTRACTOR SHALL MAINTAIN ALL WORK SITES IN A SAFE AND STABLE CONDITION.
- 4. THE CONTRACTOR SHALL BE RESPONSIBLE FOR ALL TEMPORARY WORKS.
- 5. WORKMANSHIP & MATERIALS ARE TO BE IN ACCORDANCE WITH THE SPECIFICATION WHICH SHALL TAKE PRECEDENCE OVER ANY RELEVANT STANDARDS, DRAWINGS SHALL TAKE PRECEDENCE OVER THE
- SETTING OUT AND OFF-SITE FABRICATION DIMENSIONS SHALL BE VERIFIED BY THE CONTRACTOR PRIOR TO COMMENCING WORKS.
- ALL DIMENSIONS RELEVANT TO SETTING OUT SHALL BE CONFIRMED AND VERIFIED BY THE CONTRACTOR BEFORE CONSTRUCTION IS COMMENCED. CONTRACTOR SHALL REPORT ANY DISCREPANCIES TO THE SUPERINTENDENT.
- 8. THE CONTRACTOR SHALL UNDERTAKE INVESTIGATION WORK PRIOR TO ANY DEMOLITION, EXCAVATION OR CONSTRUCTION ON THE SITE. THE CONTRACTOR SHALL CONTACT THE RELEVANT AUTHORITIES TO ASCERTAIN THE POSSIBLE LOCATION OF FURTHER SERVICES AND DETAILED LOCATION AND DEPTH OF ALL SERVICES AND ARRANGE FOR THEIR RELOCATION WHERE NECESSARY.
- THE CONTRACTOR SHALL ONLY BUILD FROM DRAWINGS WITH STATUS OF "FOR CONSTRUCTION".
 DRAWINGS HAVING ANY OTHER STATUS, INCLUDING "WORK IN PROGRESS" AND "FOR APPROVAL", MAY BE SUBJECT TO CHANGE.
- 10. NOMINATION OF PROPRIETY ITEMS DOES NOT INDICATE EXCLUSIVE PREFERENCE BUT INDICATES THE REQUIRED PROPERTIES OF THE ITEM. SIMILAR ALTERNATIVES HAVING THE REQUIRED PROPERTIES MAY BE OFFERED FOR APPROVAL. INSTALL PROPRIETY ITEMS IN ACCORDANCE WITH THE MANUFACTURER'S SPECIFICATIONS. REFER ANY DISCREPANCY TO THE SUPERINTENDENT BEFORE PROCEEDING WITH THE WORK
- 11. U.N.O. DENOTES UNLESS NOTED OTHERWISE.
- 12. C.O.S. DENOTES CONFIRM ON SITE.
- 13. EJ DENOTES EXPANSION JOINT.

DESIGN SPECIFICATIONS

- BRIDGE DESIGN STANDARD : AS5100-2017
- DESIGN LOADS : SM1600
- 3 DESIGN/OPERATION SPEED : 50km/hr
- 4. WIND LOAD (TO AS5100.2-2017 AND AS1170.2-2011):

V2000 = 48m/s (ULS BASIC DESIGN WIND SPEED)

V20 = 37m/s (SLS BASIC DESIGN WIND SPEED)
WIND REGION A1

TERRAIN CATEGORY 2

WATER FLOW FORCES

 ${\bf HYDRAULICS}~{\bf ASSESSMENT}~{\bf HAS}~{\bf NOT}~{\bf BEEN}~{\bf UNDERTAKEN}.~{\bf BRIDGE}~{\bf DESIGNED}$

FOR THE FOLLOWING NOMINAL VALUES:

V = 3m/s

DEBRIS MAT HEIGHT= 2m

EARTHQUAKE LOAD (TO AS5100.2-2017 AND AS1170.4-2007):

BRIDGE IMPORTANCE LEVEL OF 3

BEDC - 3

PROBABILITY OF EXCEEDANCE OF 1/1000 FOR ULS

PROBABILITY FACTOR: Kp = 1.3

HAZARD FACTOR: Z = 0.09 SITE SUB-SOIL CLASS: De

NO BARRIER:

TRAFFIC VOLUME CONSIDERED IS LESS THAN 150 VEHICLES PER DAY.

NO DESIGN FOR PEDESTRIAN TRAFFIC.

DESIGN REFERENCES

. BRIDGE HYDRAULIC INFORMATION

DOCUMENT No. : NCCMA REF F-2018-0112

DATE: 08 FEBRUARY 2018

FLOOD LEVEL FOR THE 1% AEP PROBABILITY (100 YEAR ARI): NOT AVAILABLE

2. GEOTECHNICAL REPORT DONE BY BLACK GEOTECHNICAL

REPORT No.: V1844R1 DATE: 20 FEBRUARY 2018

DIMENSIONS

- ALL DIMENSIONS ARE IN MILLIMETRES UNLESS NOTED OTHERWISE.
- CHAINAGES & COORDINATES ARE ALL IN METERS
- ALL COORDINATES ARE IN ARBITRARY COORDINATE SYSTEM BASED ON THE SURVEY PROVIDED BY VERIS (DRG. M02041P2 REV00).

ALL REDUCED LEVELS ARE TO ARBITRARY HEIGHT SYSTEM BASED ON THE SURVEY PROVIDED BY VERIS (DRG. M02041P2 REV00).

- DIMENSIONS SHALL NOT BE SCALED FROM DRAWINGS.
- 5. ANY DISCREPANCIES SHALL BE BROUGHT IMMEDIATELY TO THE ATTENTION OF THE SUPERINTENDENT.
- . THIS DESIGN IS BASED ON SURVEY INFORMATION PROVIDED BY VERIS (DRG. M02041P2 REV00).

CHAMFERS AND FILLETS

 UNLESS NOTED OTHERWISE, ALL EXPOSED CONCRETE EDGES HAVING A CONTAINED ANGLE LESS THEN 120° SHALL BE PROVIDED WITH 20mm FILLETS OR CHAMFERS AS APPROPRIATE

CONSTRUCTION JOINTS

- I. CJ DENOTES CONSTRUCTION JOINT
- 2. CONSTRUCTION JOINTS SHALL BE USED ONLY AS SHOWN ON THE DRAWINGS.
- NO CONSTRUCTION JOINTS SHOWN ON THE DRAWINGS SHALL BE OMITTED WITHOUT THE WRITTEN APPROVAL OF THE SUPERINTENDENT.
- CONSTRUCTION JOINTS WHERE NOT SHOWN SHALL BE LOCATED TO THE APPROVAL OF THE SUPERINTENDENT. CONTRACTORS SHALL ALLOW FOR ALL NECESSARY CONSTRUCTION JOINTS.

REINFORCEMENT

- REINFORCEMENT SYMBOLS
 - N HOT ROLLED DEFORMED BARS TO AS4671 GRADE 500N
 - R STRUCTURAL GRADE PLAIN ROUND BAR TO AS 4671 GRADE 250
- 2. ALL REINFORCEMENT IS DESIGNATED AS FOLLOWS:
 - e.g. 8 N12-150 T
 - THE NUMBER PRECEDING THE BAR SYMBOL (8) IS THE NUMBER OF BARS
 - THE NUMBER FOLLOWING THE BAR SYMBOL (12) IS THE NOMINAL BAR DIAMETER IN MILLIMETRES
 - THE NUMBER FOLLOWING THE 'DASH' (150) IS THE SPACING IN MILLIMETRES
 - THE LETTER FOLLOWING THE SPACING (T) IS THE LOCATION OF THE BAR IN THE ELEMENT AS FOLLOWS:

Т	TOP
В	BOTTOM
NF	NEAR FACE
FF	FAR FACE
EF	EACH FACE
LV	LENGTH VARIES
EW	EACH WAY

- 3. REINFORCEMENT SPACING NOT SHOWN SHALL BE TAKEN AS EQUAL.
- REINFORCING BAR SHOWN ON THESE DRAWINGS ARE DIAGRAMMATIC ONLY. IT IS NOT NECESSARILY SHOWN IN TRUE PROJECTION.
- 5. BARS SHOWN MAY REPRESENT MORE THAN ONE LENGTH AND/OR PROFILE.
- 6. BARS MAY NOT BE SHOWN IN TRUE POSITION FOR CLARITY.
- . ALL HOOKS, BEND AND COGS ARE STANDARD AND SHALL BE IN ACCORDANCE WITH AS5100 BRIDGE DESIGN 2004 UNLESS NOTED OTHERWISE.
- . ALL REINFORCEMENT IS DIMENSIONED OUT-TO-OUT ALONG EACH STRAIGHT PORTION OF THE BAR.
- 9. WELDING OF REINFORCEMENT NOT PERMITTED UNLESS NOTED OTHERWISE.
- 0. ALL REINFORCEMENT IS DESIGNATED AS FOLLOWS UNLESS IT IS DESCRIBED

FULLY IN ACCO	RDANCE WITH AS 4671 SECTION 5	i.
SYMBOL	DESCRIPTION	TYPE TO AS 4671
SL	MESH-SQUARE GRID	D500L
RL	MESH-RECTANGULAR GRID	D500L
R	PLAIN BARS	R250N
S	DEFORMED BARS	D250N
N	DEEODMED DADG	DECON

FULL DESCRIPTION EXAMPLE: D500N16 (16 DIA DEFORMED BAR)

LAP LENGTHS FOR REINFORCEMENT

 LAPS AND OTHER SPLICES IN REINFORCEMENT SHALL ONLY BE MADE AT THE POSITION SHOWN ON THE DRAWINGS, UNLESS ALTERNATIVE OR EXTRA LOCATIONS ARE APPROVED IN WRITING BY THE SUPERINTENDENT. LAP LENGTHS SHALL BE AS TABULATED BELOW UNLESS SHOWN OTHERWISE ON THE DRAWINGS.

	BAR DIAMETER	MIN. LAP LENGTH
Ī	12	300
	16	500
	20	750
	24	1000
	28	1250
	32	1550
	36	1850

(NOTE: THE MINIMUM LAP LENGTH SHOWN SHALL BE INCREASED BY 25% FOR HORIZONTAL BARS WITH 300mm OR MORE CONCRETE CAST BELOW THE BAR.)

- REINFORCEMENT SPLICES SHALL BE STAGGERED AND NO MORE THAN 50% OF SPLICES SHALL BE AT ANY ONE SECTION UNLESS SHOWN OTHERWISE.
- 3. WHERE MORE THAN HALF THE BARS ARE SPLICED AT ANY ONE SECTION, THE SPLICE LENGTHS SHALL BE INCREASED BY 30%

CONCRETE

- CONCRETE BLINDING LAYERS SHALL BE MINIMUM 50 THICK.
- 2. MAXIMUM AGGREGATE SIZE SHALL BE 20mm
- CONCRETE TO BE USED IN EACH ELEMENT OF THE WORK SHALL BE OF THE GRADE SHOWN BELOW UNLESS NOTED OTHERWISE ON THE DRAWINGS. THE GRADE DESIGNATION SPECIFIES THE CONCRETE STRENGTH.
- 4. EXPOSURE CLASSIFICATION B1 (TYPICAL).

ELEMENT	CONCRETE GRADE	CHARACTERISTIC COMP. STRENGTH AT 28 DAYS (MPa)	MIN. COVER (mm)
ABUTMENTS	VR 400/40	40	40, 70*
PRECAST PLANKS	VR 450/50	50	35**
DECK	VR 400/40	40	45(T), 35(B)
APPROACH SLABS	VR 400/40	40	40, 70*
PRECAST PILES	VR 450/50	50	40
PIERS	VR 400/40	40	40

- * ELEMENTS CAST AGAINST GROUND.
- ** RIGID FORMWORK AND INTENSE COMPACTION TO BE USED.

PILES

 SHOWN PILE TOE LEVELS ARE INDICATIVE ONLY AND ACTUAL PILE LENGTHS MAY VARY FROM THOSE INDICATED AS NECESSARY TO ACHIEVE THE REQUIRED PILE CAPACITY WITHIN THE VARYING SOIL CONDITIONS.

STRUCTURAL STEELWORK

- 1. ALL WORKMANSHIP AND MATERIALS SHALL BE ACCORDANCE WITH AS 5100.
- WELDING SHALL BE PERFORMED BY A QUALIFIED OPERATOR IN ACCORDANCE WITH AS 1554.
- 3. STRUCTURAL STEEL SHALL BE GRADE 300, UNLESS NOTED OTHERWISE.
- BOLTS AND NUTS TO AS 1252 GRADE 8.8/S UNLESS NOTED OTHERWISE. WASHERS TO AS 1237
 STEEL PLATE SHALL BE GRADE 350 & COMPLY WITH AS 3678. UNLESS NOTED OTHERWISE.
- 5. STEEL PLATE SHALL BE GRADE 350 & COMPLY WITH AS 3678, UNLESS NOTED OTHERWISE.
- SHS, RHS & CHS SHALL BE GRADE 350 AND COMPLY WITH AS 1163, UNLESS NOTED OTHERWISE.
 ALL BOLTS, NUTS & WASHERS TO BE HOT DIPPED GALV.
- 8. ALL WELDS TO BE 6mm CONTINUOUS FILLET WELDS UNLESS NOTED OTHERWISE.
- . ALL STEELWORK SHALL BE HOT DIPPED GALV. AFTER FABRICATION.
- GALVANIZING SHALL COMPLY WITH AS/NZS 4680.
 WELDING SHALL BE CATEGORY SP WITH E48XX ELECTRODES TO COMPLY WITH AS/NZS 1554-PART 1.
- 12. CAST-IN ANCHOR ASSEMBLY SHALL BE HOT-DIP GALVANIZED. AFTER ASSEMBLY, GALVANIZED SURFACES SHALL BE RENOVATED WITH TWO PACK INORGANIC ZINC-RICH PRIMER.
- 13. BOLT TYPES SHALL BE AS FOLLOWS:

PREVENT VIBRATION LOOSENING.

ALL BOLTS SHALL BE HOT DIP GALVANISED TO AS/NZS 4680:1999. 4.6/S COMMERCIAL BOLTS TO AS 1111, SNUG TIGHTENED.

8.8/S HIGH STRENGTH STRUCTURAL BOLTS, WITH BOLTS, NUTS AND HARDENED WASHER TO AS 5100.6 / AS 1252:1996.

 $8.8 \mbox{/TB}$ HIGH STRENGTH STRUCTURAL BOLTS AS ABOVE, FULLY TENSIONED TO AS 5100.6 IN A BEARING TYPE JOINT.

THE LENGTH OF A BOLT SHALL BE SUCH THAT AT LEAST ONE CLEAR THREAD SHOWS ABOVE THE NUT AND

8.8/TF HIGH STRENGTH STRUCTURAL BOLTS AS ABOVE, FULLY TENSIONED TO AS 5100.6 IN A FRICTION TYPE JOINT AND U.N.O. WITH FAYING SURFACES LEFT UNCOATED.

14. SLOTTED HOLES AND WASHERS TO BE FABRICATED AND INSTALLED IN ACCORDANCE WITH AS 5100.6

AT LEAST ONE THREAD PLUS THE THREAD RUN OUT IS CLEAR BEYOND THE NUT AFTER TIGHTENING.

16. ONE FULL AND ONE HALF NUT MUST BE USED IN ORDER TO ACHIEVE A SOUND LOCKING MECHANISM TO

SAFETY IN DESIGN

 FOR SAFETY IN DESIGN REFER TO THE BRIDGE DESIGN REPORT P.23.0690-00-STR-DRG-M003 REP 16P.

WARNING

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FOR TENDER
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PROJECT VAUGHAN-TARILTA ROAD

BRIDGE FOR TENDER

IENT MOUNT ALEXANDER SHIRE COUNCIL


GENERAL NOTES


DATUMS: AHD / MGA

CLIENT NO._

DRAWING NO. S-P.23.0690-00-STR-DRG-S302

REVISION B

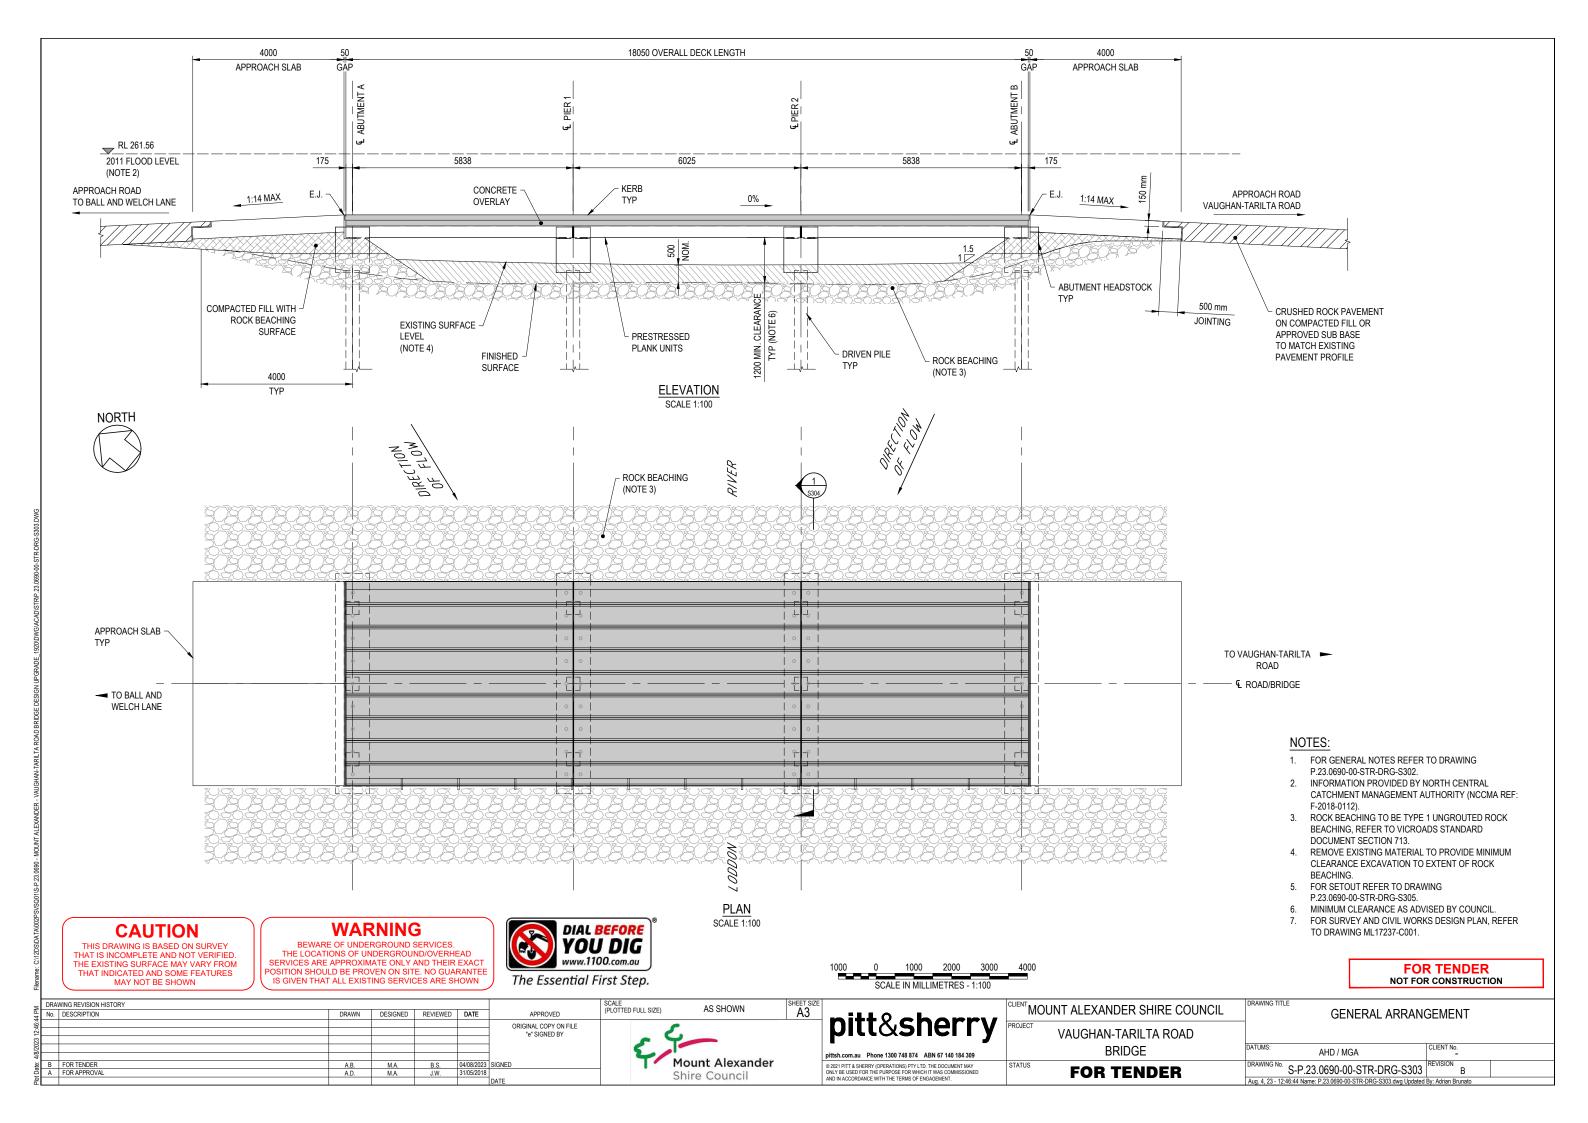

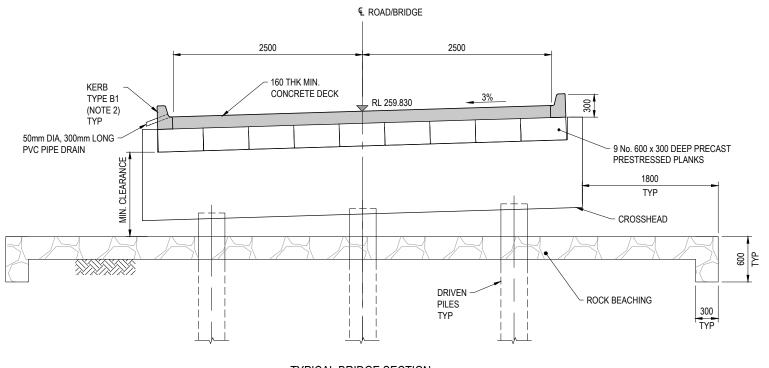

TYPICAL BRIDGE SECTION

SECTION 1 SCALE 1:50 S303

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500 0 500 1000 1500 2000 SCALE IN MILLIMETRES - 1:50

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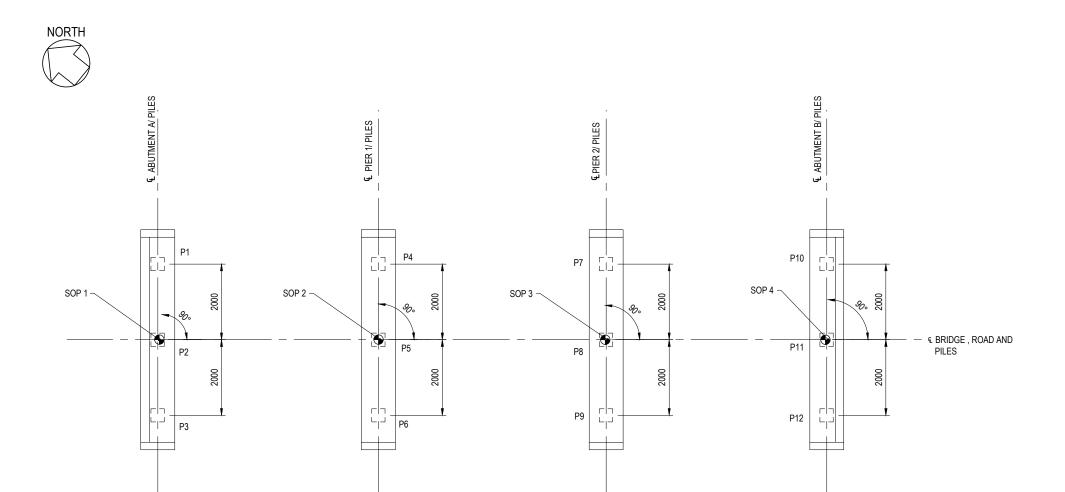
_	CLIENT MOUNT ALEXANDER SHIRE COUNCIL		
7	VAUGHAN-TARILTA ROAD		
	BRIDGE		

FOR TENDER

	SECTION	
	DATUMS: AHD / MGA	CLIENT No.
	DRAWING No. S-P.23.0690-00-STR-DRG-S304	REVISION B
_	Aug. 4, 23 - 12:46:45 Name: P.23.0690-00-STR-DRG-S304.dwg Updated	By: Adrian Brunato

NOTES

1. FOR GENERAL NOTES, REFER TO DRAWING P.23.0690-00-STR-DRG-S302.
2. FOR KERB DETAILS, REFER TO VICROADS STANDARD DRAWING SD2001.



SETOUT POINTS						
POINT	NORTHING					
SOP 1	252152.849	5884063.491				
SOP 2	252157.242	5884059.647				
SOP 3	SOP 3 252161.775					
SOP 4	252166.168	5884051.834				

PILE SCHEDULE					
PILE No.	TOP CUT OFF RL	ESTIMATED TOE RL			
P1	258.607	249.697			
P2	258.520	249.610			
P3	258.433	249.523			
P4	258.607	249.697			
P5	258.520	249.610			
P6	258.433	249.523			
P7	258.607	249.697			
P8	258.520	249.610			
P9	258.433	249.523			
P10	258.607	249.697			
P11	258.520	249.610			
P12	258.433	249.523			

FOUNDATION PLAN SCALE 1:100

- NOTES

 1. FOR GENERAL NOTES REFER TO DRG. P.23.0690-00-STR-DRG-S302.
- ALL PILES ARE TO BE INSTALLED VERTICALLY.
- REFER TO DRG. P.23.0690-00-STR-DRG-S306 FOR PILE DETAILS.
- REFER TO GEOTECHNICAL INVESTIGATION REPORT PREPARED BY BLACK GEOTECHNICAL (REPORT No. V1844R1/20 FEBRUARY 2018).
- SETOUT POINTS ARE LOCATED ON INTERSECTIONS OF BRIDGE
- CENTERLINE AND PIER OR ABUTMENT CENTERLINE.

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DRAWING REVISION HISTORY
No. DESCRIPTION

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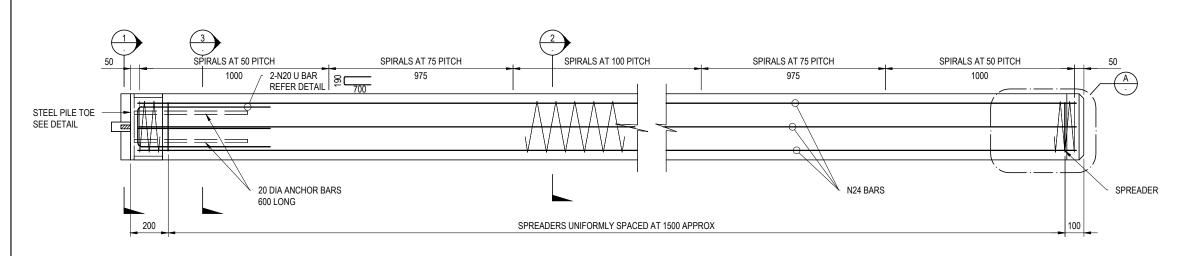
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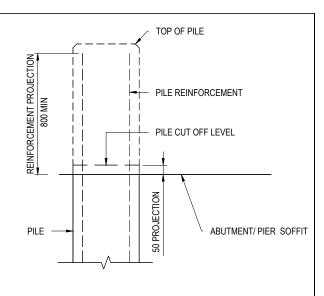
SCALE (PLOTTED FULL SIZE) A3 AS SHOWN Mount Alexander Shire Council

Ε						CLIENT MOLIN	
		SCAL	E IN MILLI	METRES -	1:100		
	1000	0	1000	2000	3000	4000	

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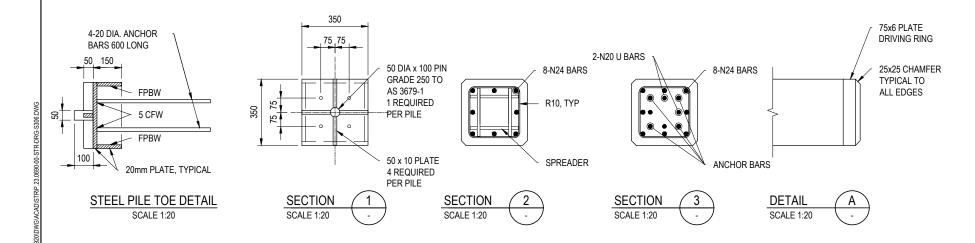
A3	nill 0 abanny	CLIENT MOUNT ALEXANDER SHIRE COUNCIL	FOUNDATION LAYOUT
	pitt&sherry	VAUGHAN-TARILTA ROAD	
	pittsh.com.au Phone 1300 748 874 ABN 67 140 184 309	BRIDGE	DATUMS: AHD / MGA CLIENT No.
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	AND IN ACCORDANCE WITH THE TERMS OF ENGAGEMENT.	. On this en	Aug. 4, 23 - 12:46:47 Name: P.23.0690-00-STR-DRG-S305.dwg Updated By: Adrian Brunato






PILE ELEVATION SCALE 1:20

TYPICAL PILE CUT OFF LEVEL DETAIL SCALE 1:20



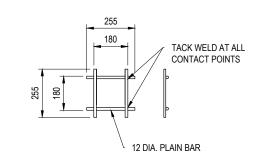

SPREADER SCALE 1:20

	ı	PILE LO	AD - N (kN)	
	ULTIMATE LIMIT STATE	ULTIMATE	LUTINANTE	P.D.A. TESTING	
LOCATION	DESIGN AXIAL LOAD (kN)	BENDING MOMENT (kNm)	ULTIMATE SHEAR (kN)	REPRESENTATIVE PILE	REPRESENTED PILE
ABUTMENTS	370	90	150	672	903
PIER	370	90	150	672	903

POSITION SHOULD BE PROVEN ON SITE, NO GUARANTEE

PILE LOAD NOTES

- REFER TO VICROADS STANDARD DOCUMENT SECTION 605 FOR PILE SPECIFICATION TESTING REQUIREMENTS.
- N*=Nφ
- N° ULTIMATE LIMIT STATE DESIGN AXIAL LOAD PER PILE.
 N CHARACTERISTIC ULTIMATE AXIAL RESISTANCE PER PILE. φ - MATERIAL FACTOR
- 3. THE FOLLOWING PARTIAL MATERIAL FACTORS HAVE BEEN USED. REPRESENTATIVE PILES; φ₁=0.8 (ASSUMED CAPWAP ANALYSIS OR SIMILAR) ϕ_4 =1.0 (NO SPLICING JOINT) REPRESENTED PILES

φ₂=0.7 (ASSUMED DRIVEN TO SELECTED SET) φ₃=0.85 (VARIATION IN SOIL PROFILE)

φ₄=1.0 (NO SPLICING JOINT)

 ϕ_5 =1.0 (ASSUME 15% OF PILES TO BE LOAD TESTED)

200 400

NOTES

- MINIMUM 28 DAY COMPRESSIVE STRENGTH OF CONCRETE SHALL BE 50 MPa.
- CONCRETE EXPOSURE CLASSIFICATION B1.
- CONCRETE EDGES SHALL BE CHAMFERED 25x25 mm
- COVER TO REINFORCEMENT NEAREST TO THE CONCRETE SURFACE SHALL BE 40mm.
- THE MINIMUM SPECIFIED COVER IS BASED ON THE PILE BEING CAST IN RIGID FORMWORK WITH INTENSE COMPACTION USING VIBRATING TABLE OR FORM VIBRATORS.
- MINIMUM LAP LENGTH OF SPIRAL SHALL BE 1.5 TURNS.
- END OF SPIRAL AT PILE HEAD AND TOE SHALL BE ANCHORED BY A HOOK AROUND A MAIN BAR AND 300mm (MINIMUM) EXTENSION INTO CORE CONCRETE.
- THE NOMINATED LOADS APPLY TO THE STRUCTURE AS DESIGNED. ANY PROPOSED CHANGES TO THE PILES AND PILE LAYOUT MAY SIGNIFICANTLY ALTER THE BEHAVIOUR OF THE STRUCTURE, AND MUST BE SUBMITTED TO THE PRINCIPAL FOR APPROVAL PRIOR TO COMMENCEMENT OF PILING OPERATIONS.
- PILES SHALL BE PROJECTED 50mm INTO CROSSHEAD AND PILE CAPS.
- PILE REINFORCEMENT SHALL PROJECT 800mm MIN. INTO ABUTMENT CROSSHEADS OR PILE CAPS.
- 11. PILE CAPACITY TO BE ASSESSED ON SITE USING PILE DRIVING ANALYSER. ONE PILE IN EACH GROUP SHALL BE DRIVEN AND TESTED.
- 12. ALL PILES SHALL BE DRIVEN TO EFFECTIVE REFUSAL INTO SILTSTONE STRATUM.
- 13. IF THE REQUIRED DESIGN LOAD IS NOT ATTAINED WHEN A PILE HAS BEEN DRIVEN TO THE REQUIRED FOUNDING LEVEL, PILE DRIVING SHALL CEASE. THE PILE SHALL BE LEFT FOR 48 HOURS TO ALLOW FOR SET-UP TO DEVELOP. THE ACTUAL PILE CAPACITY SHALL THEN BE VERIFIED BY RE-STRIKE.
- 14. REFER TO GEOTECHNICAL REPORT No. V1844R1 BY BLACK GEOTECHNICAL DATED 20 FEBRUARY 2018 FOR SUBSURFACE CONDITIONS.

CAUTION


THIS DRAWING IS BASED ON SURVEY THE EXISTING SURFACE MAY VARY FROM THAT INDICATED AND SOME FEATURES
MAY NOT BE SHOWN


WARNING BEWARE OF UNDERGROUND SERVICES THE LOCATIONS OF UNDERGROUND/OVERHEAD SERVICES ARE APPROXIMATE ONLY AND THEIR EXACT





FOR TENDER NOT FOR CONSTRUCTION

DRAWING REVISION HISTORY ^{ENT}MOUNT ALEXANDER SHIRE COUNCIL (PLOTTED FULL SIZE) AS SHOWN PILE DETAILS ORIGINAL COPY ON FILE VAUGHAN-TARILTA ROAD "e" SIGNED BY CLIENT No **BRIDGE** AHD / MGA DRAWING No. S-P.23.0690-00-STR-DRG-S306 Mount Alexander © 2021 PITT & SHERRY (OPERATIONS) PTY LTD. THE DOCUMENT MAY ONLY BE USED FOR THE PURPOSE FOR WHICH IT WAS COMMISSIONED AND IN ACCORDANCE WITH THE TERMS OF ENGAGEMENT. **FOR TENDER** Shire Council Aug. 4, 23 - 12:46:49 Name: P.23.0690-00-STR-DRG-S306.dwg Updated By: Ac

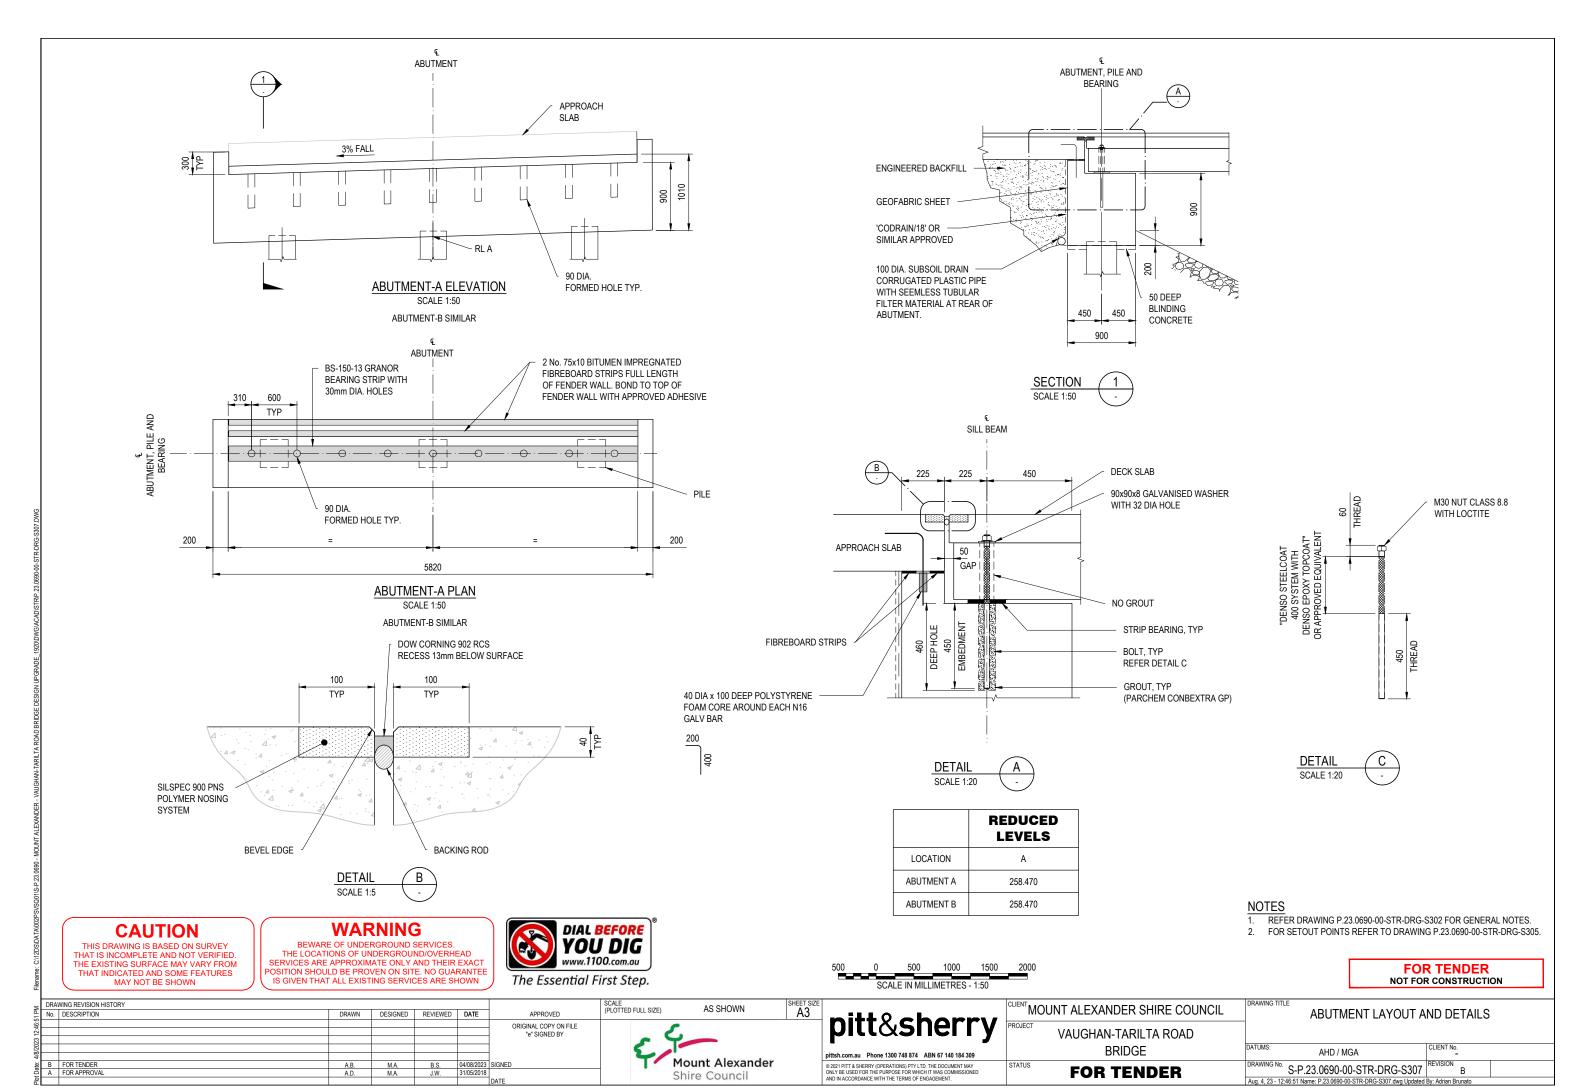


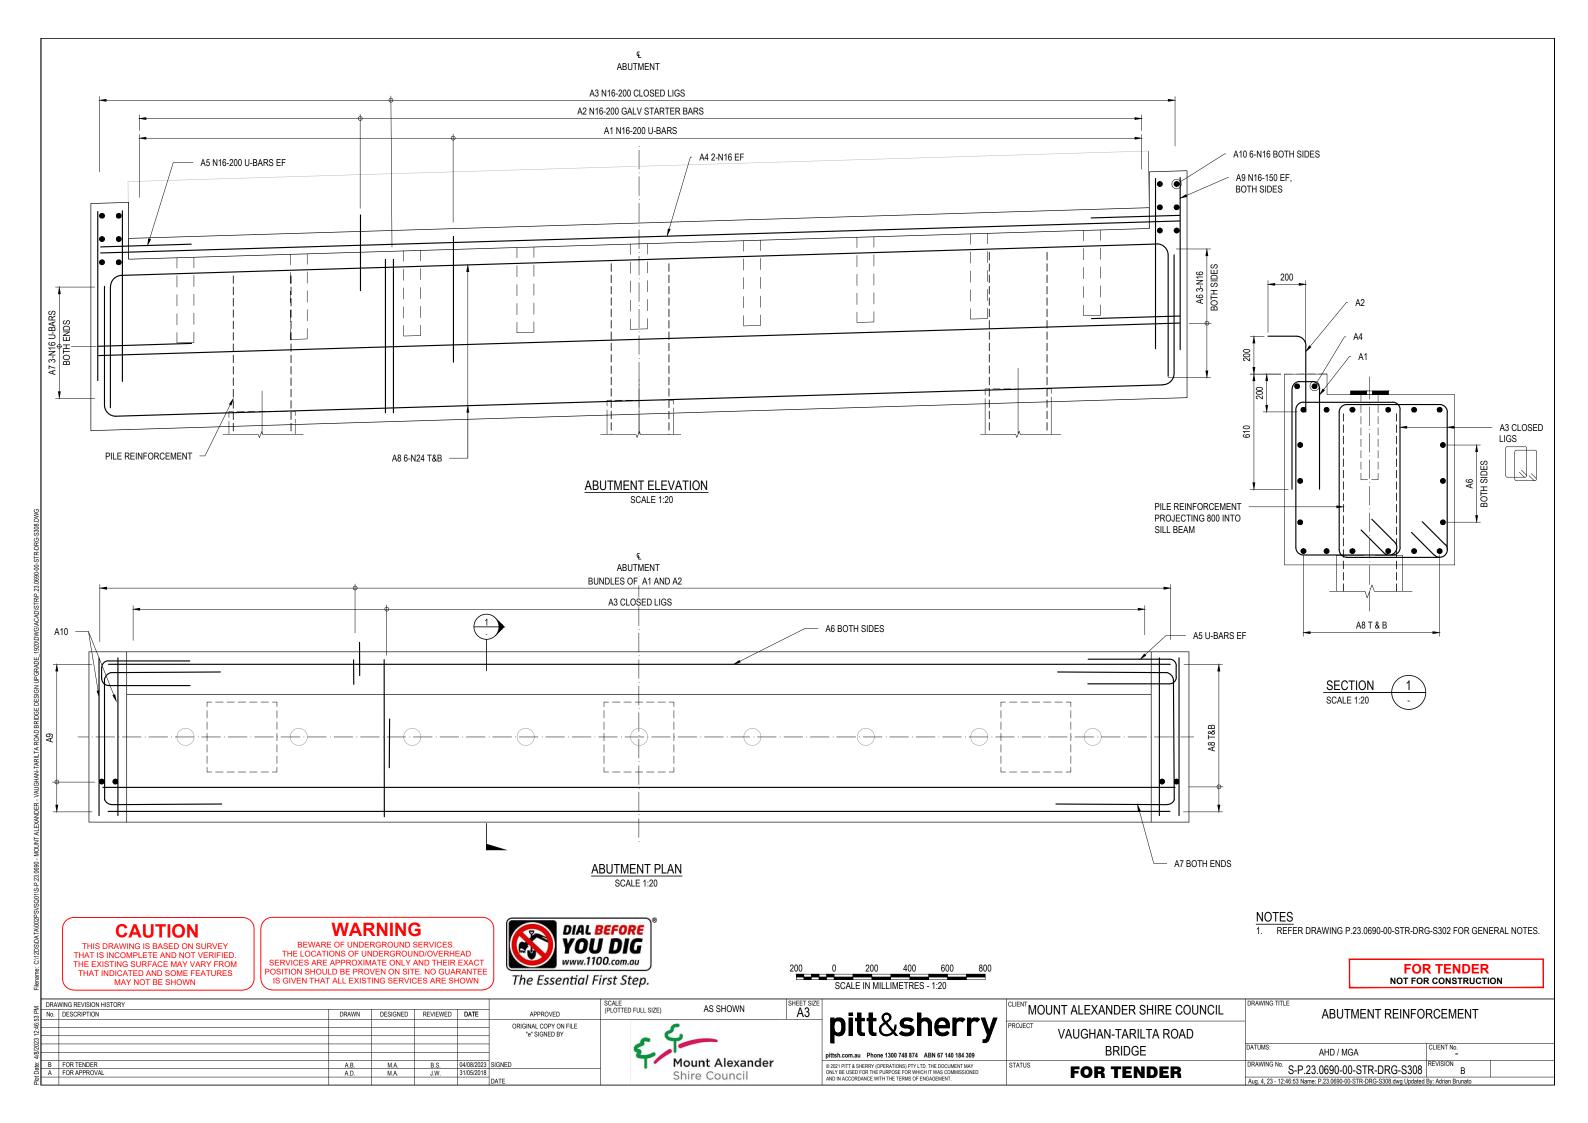


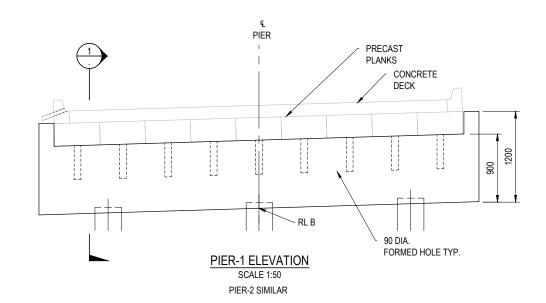

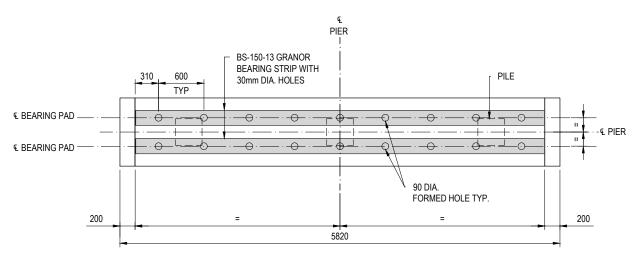

PIER-1 PLAN SCALE 1:50 PIER-2 SIMILAR

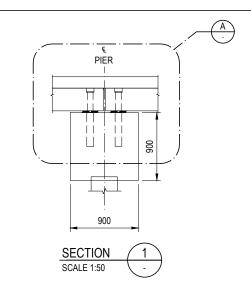

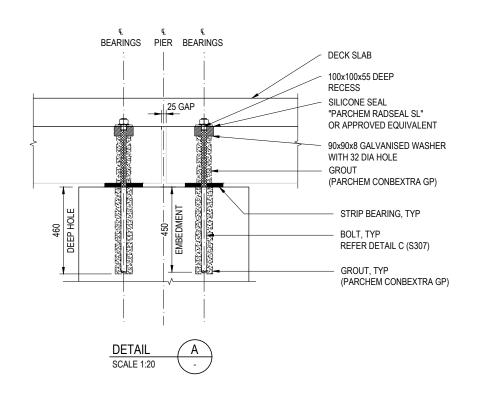

	REDUCED LEVELS
LOCATION	В
PIER 1	258.470
PIER 2	258.470

CAUTION

THIS DRAWING IS BASED ON SURVEY THAT IS INCOMPLETE AND NOT VERIFIED. THE EXISTING SURFACE MAY VARY FROM THAT INDICATED AND SOME FEATURES MAY NOT BE SHOWN

WARNING

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POSITION SHOULD BE PROVEN ON SITE. NO GUARANTEE
IS GIVEN THAT ALL EXISTING SERVICES ARE SHOWN



500 0 500 1000 1500 2000 SCALE IN MILLIMETRES - 1:50

NOTES

1. REFER DRAWING P.23.0690-00-STR-DRG-S302 FOR GENERAL NOTES.

FOR SETOUT POINTS REFER TO DRAWING P.23.0690-00-STR-DRG-S305.

Aug. 4, 23 - 12:46:55 Name: P.23.0690-00-STR-DRG-S309.dwg Updated By: Adrian Bruna

DRAWING REVISION HISTORY

No. DESCRIPTION

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DESIGNED

REVIEWED

DATE

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e SIGNED BY

B FOR TENDER

A FOR APPROVAL

A PROVED

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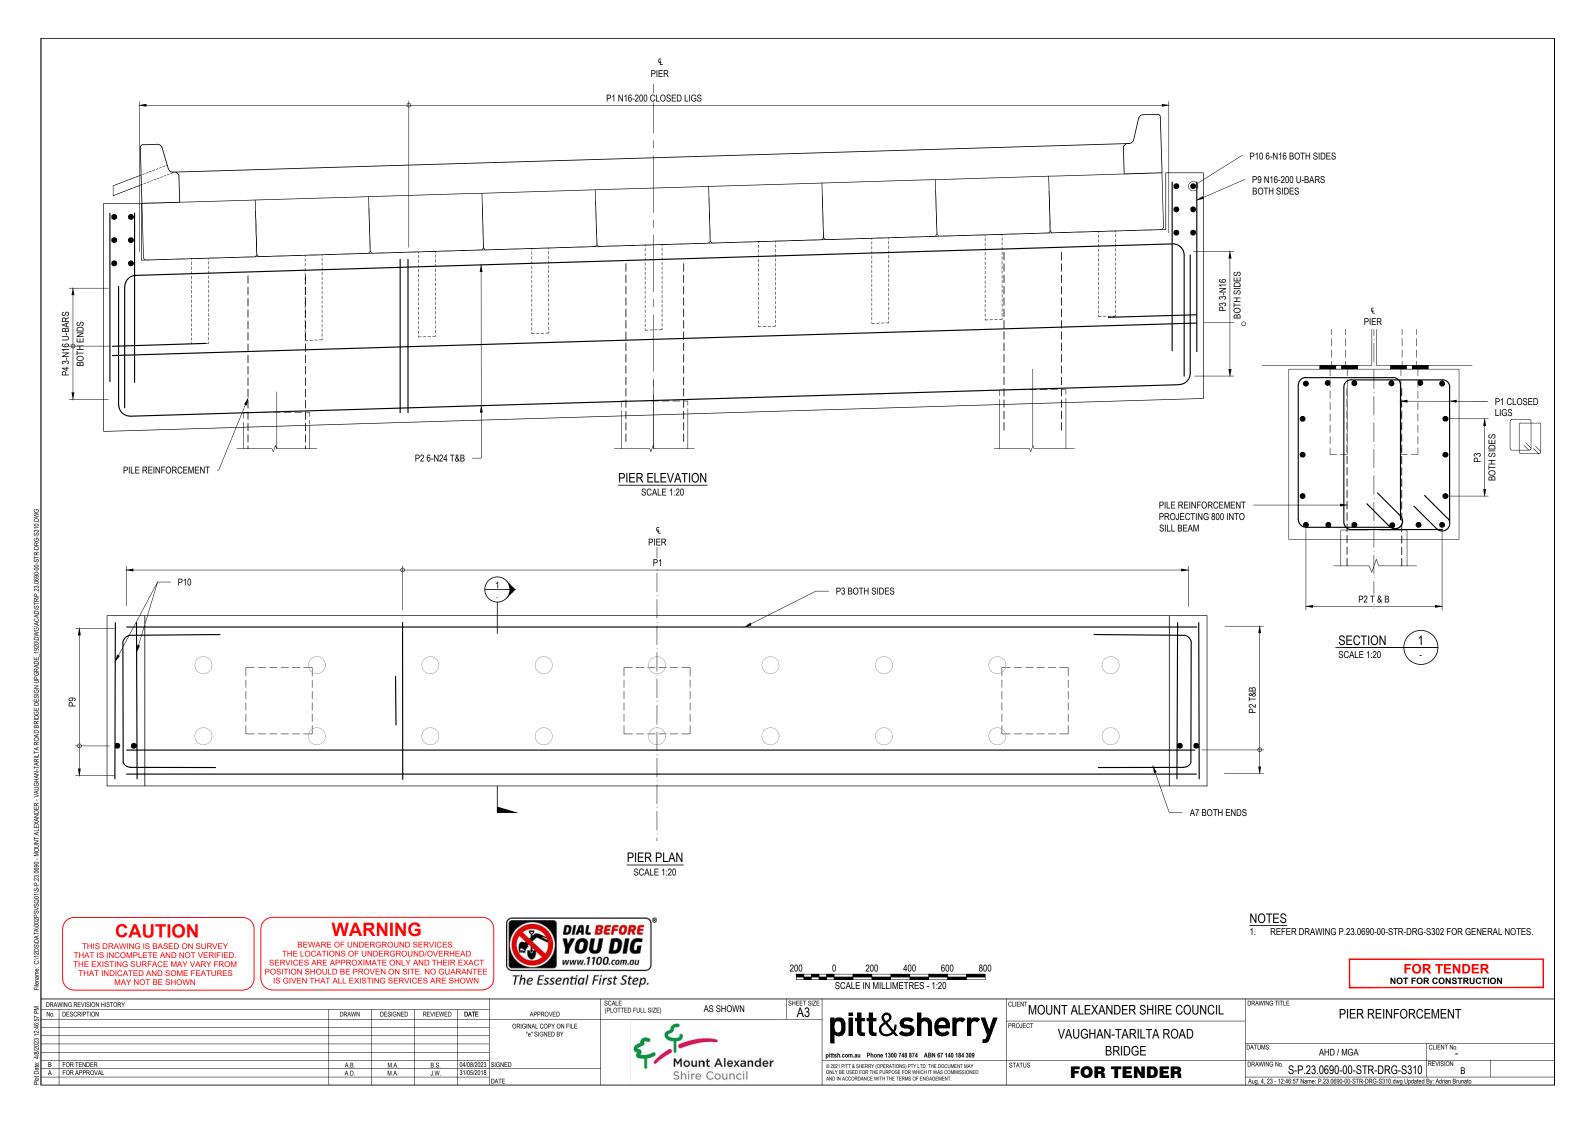
MOUNT Alexander


Shire Council


	CLIENT MOUNT ALEXANDER SHIRE CO
pitt&sherry	VAUGHAN-TARILTA ROA
pittsh.com.au Phone 1300 748 874 ABN 67 140 184 309	BRIDGE
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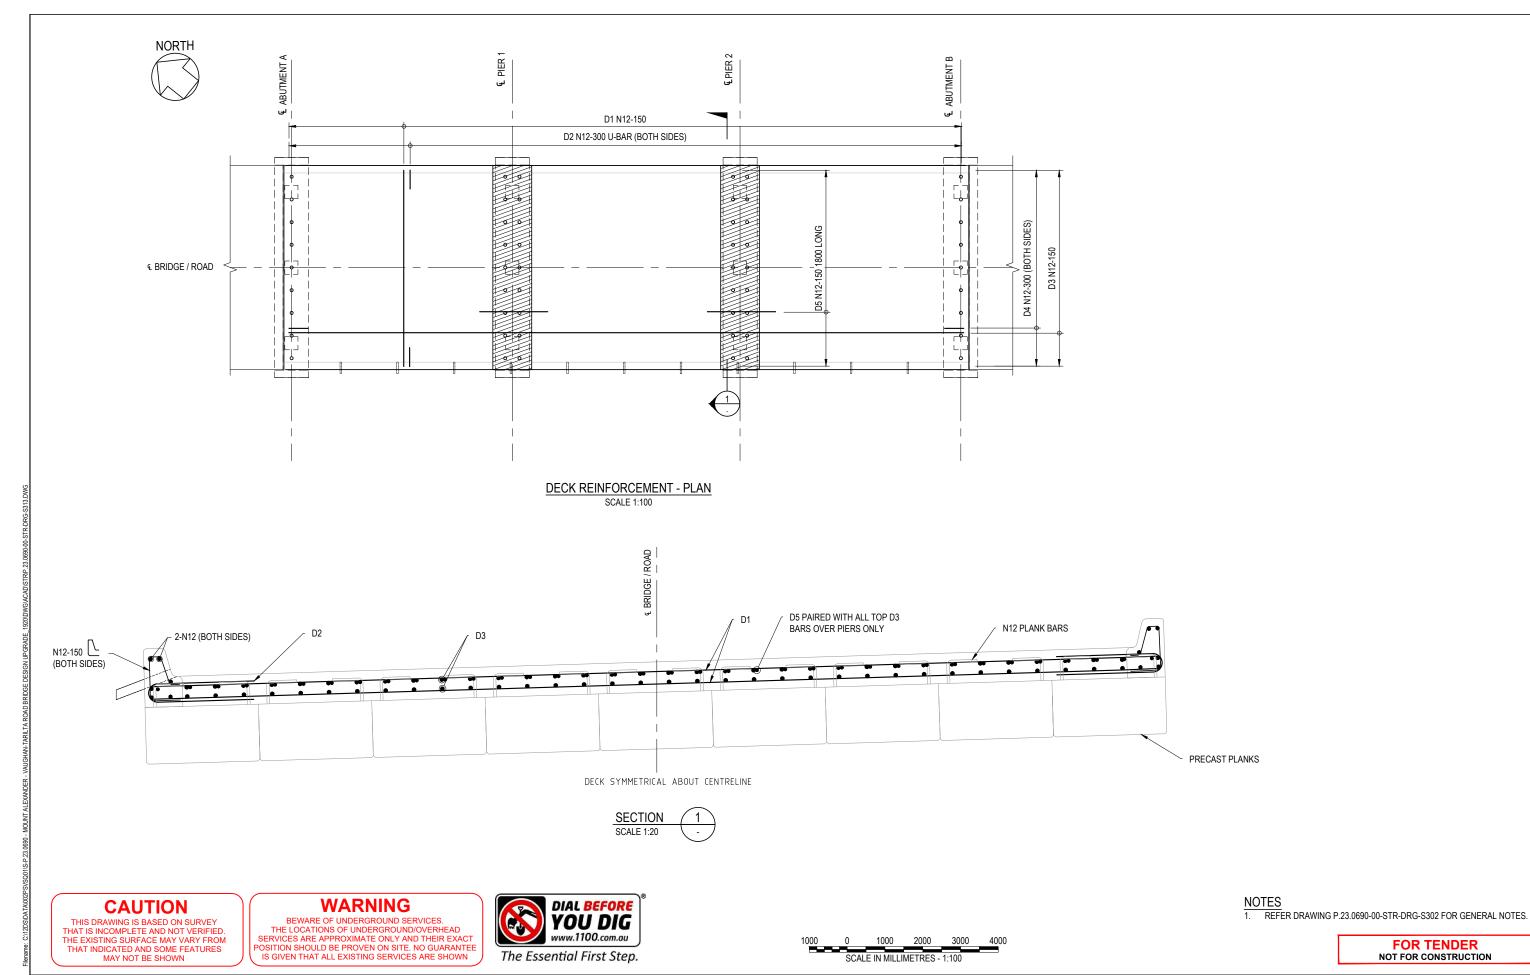
FOR TENDER	DRAWING No. S-P.23.0690-00-STR-DRG-S309	REVISION B
BRIDGE	DATUMS: AHD / MGA	CLIENT No.
VAUGHAN-TARILTA ROAD		
™MOUNT ALEXANDER SHIRE COUNCIL	PIER LAYOUT AND [DETAILS

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SCALE (PLOTTED FULL SIZE)

ORIGINAL COPY ON FILE "e" SIGNED BY

AS SHOWN

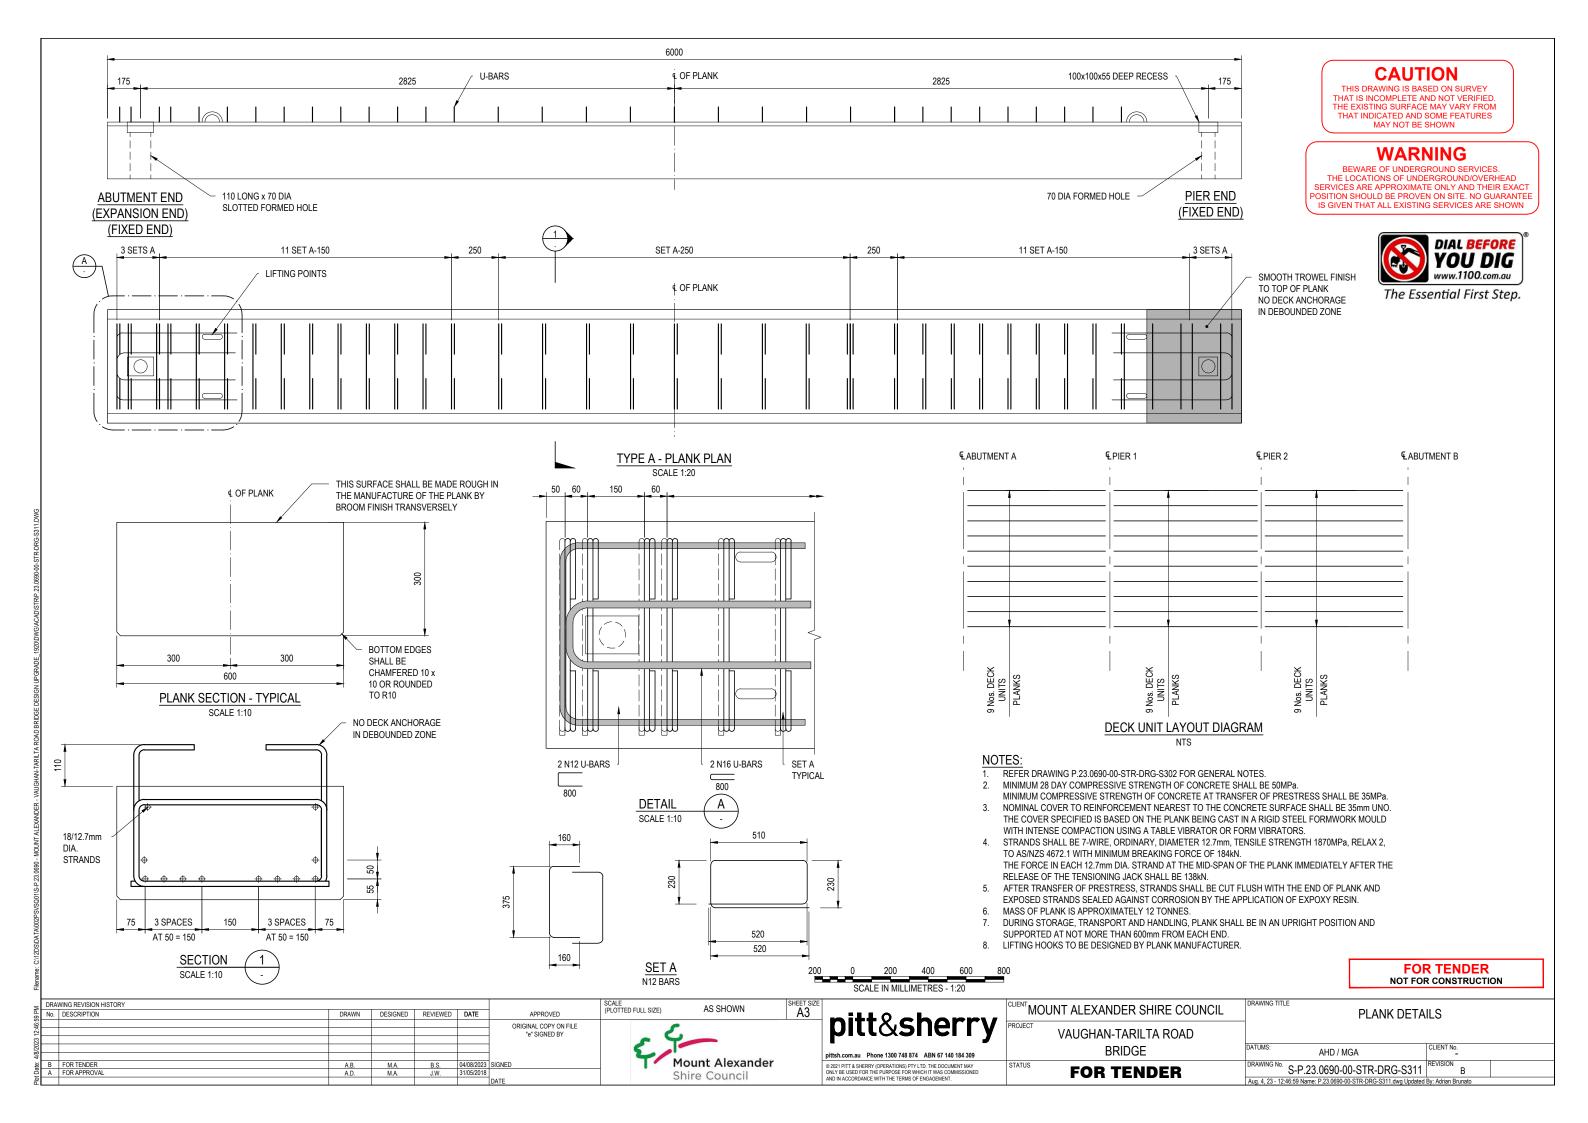Mount Alexander

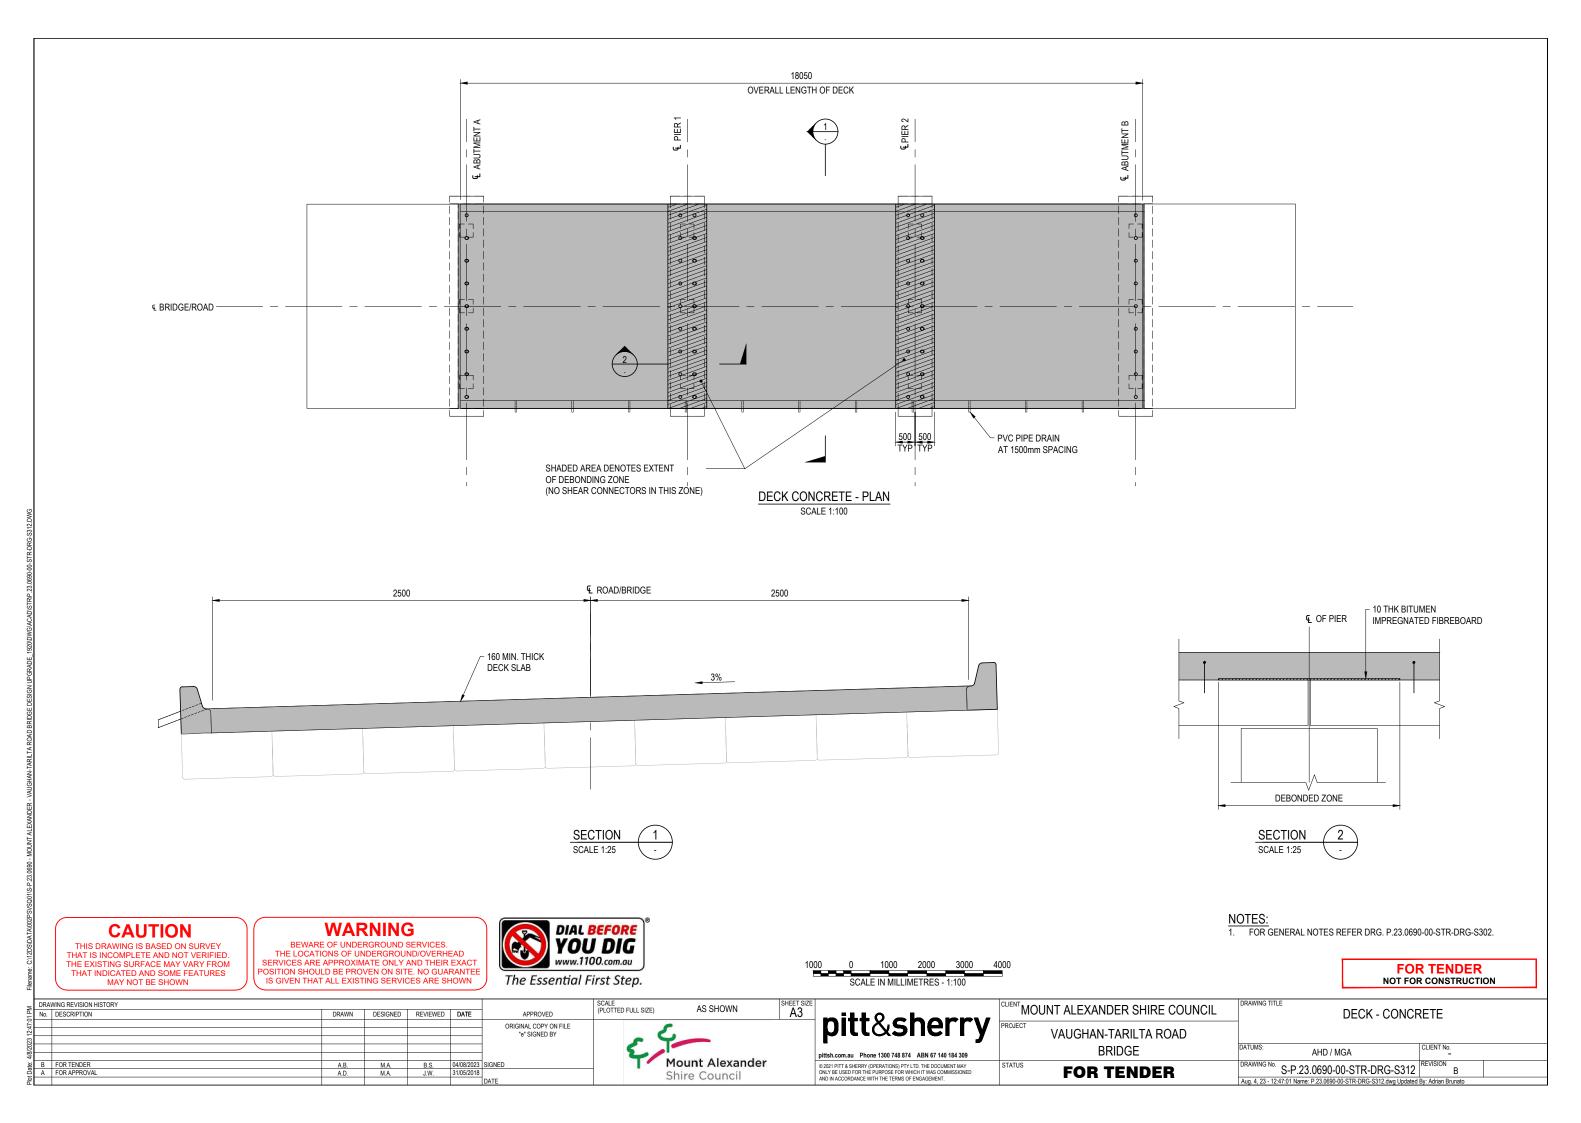Shire Council


DRAWING REVISION HISTORY

B FOR TENDER
A FOR APPROVAL

LIENT MOUNT ALEXANDER SHIRE COUNCIL **DECK - REINFORCEMENT** VAUGHAN-TARILTA ROAD CLIENT No BRIDGE AHD / MGA DRAWING No. S-P.23.0690-00-STR-DRG-S313 REVISION © 2021 PITT & SHERRY (OPERATIONS) PTY LTD. THE DOCUMENT MAY ONLY BE USED FOR THE PURPOSE FOR WHICH IT WAS COMMISSIONED AND IN ACCORDANCE WITH THE TERMS OF ENGAGEMENT. **FOR TENDER**

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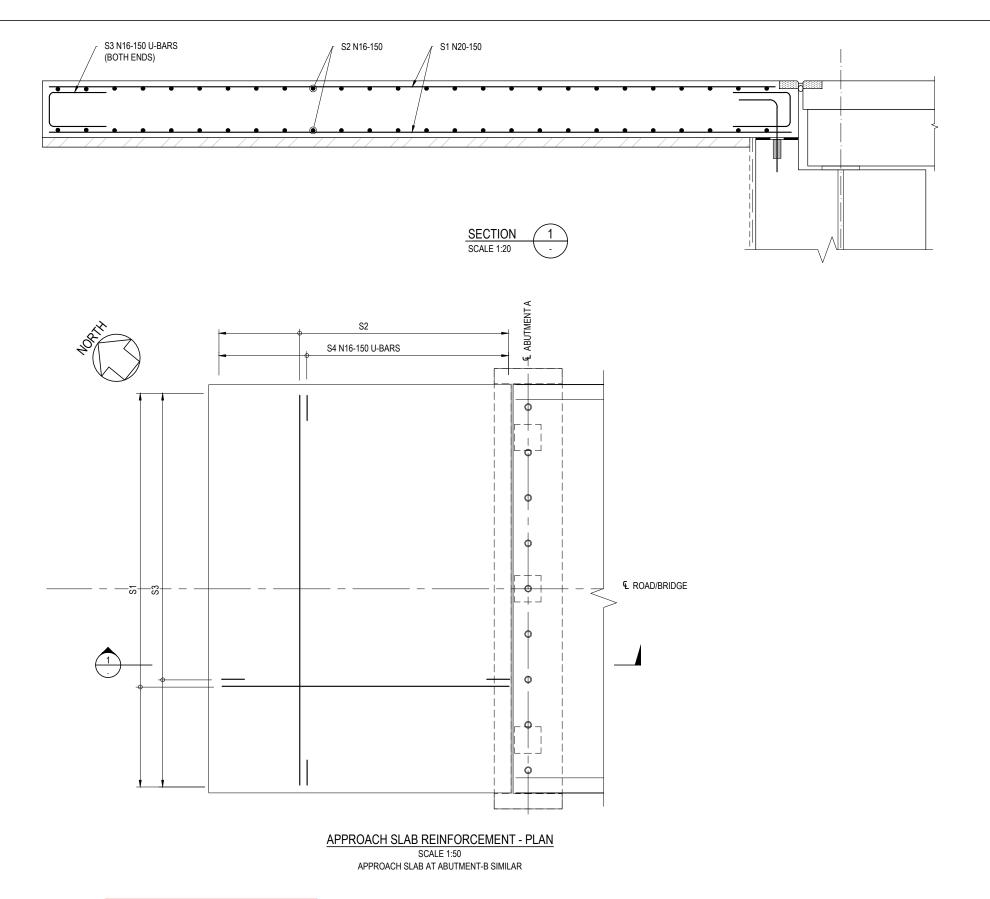
500 1000 1500 SCALE IN MILLIMETRES - 1:50

1. REFER DRAWING P.23.0690-00-STR-DRG-S302 FOR GENERAL NOTES.
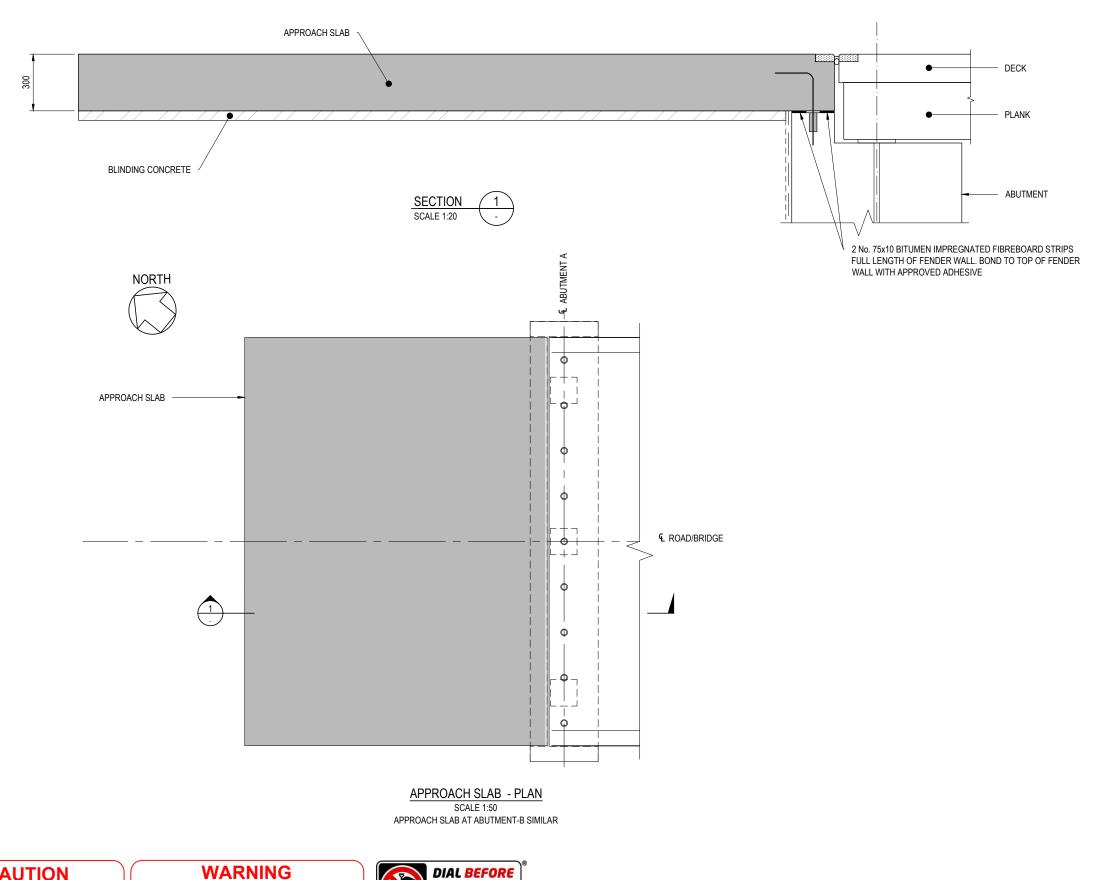
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DRAWING REVISION HISTORY

No. DESCRIPTION SCALE (PLOTTED FULL SIZE) AS SHOWN LIENT MOUNT ALEXANDER SHIRE COUNCIL APPROACH SLAB - CONCRETE ORIGINAL COPY ON FILE "e" SIGNED BY VAUGHAN-TARILTA ROAD CLIENT No BRIDGE AHD / MGA B FOR TENDER
A FOR APPROVAL DRAWING No. S-P.23.0690-00-STR-DRG-S314 REVISION M.A. B.S. 04/08/2023 SIGNED M.A. J.W. 31/05/2018 Mount Alexander © 2021 PITT & SHERRY (OPERATIONS) PTY LTD. THE DOCUMENT MAY ONLY BE USED FOR THE PURPOSE FOR WHICH IT WAS COMMISSIONED AND IN ACCORDANCE WITH THE TERMS OF ENGAGEMENT. **FOR TENDER** Shire Council



CAUTION

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1000 0 1000 2000 3000 4000 SCALE IN MILLIMETRES - 1:100

NOTES

1. REFER DRAWING P.23.0690-00-STR-DRG-S302 FOR GENERAL NOTES.

FOR TENDER
NOT FOR CONSTRUCTION

≥_	DRAWING REVISION HISTORY					SCALE (PLOTTED FULL SIZE) AS SHOWN	SHEET SIZE A3	CLIENT MOUNT ALEXANDER SHIRE COUNCIL	DRAWING TITLE
9 9	No. DESCRIPTION	DRAWN	DESIGNED REV	/IEWED DATE	APPROVED	(FLOTTED FOLL SIZE) //O OTTOWN	A3 mill O mb manns	MOUNT ALEXANDER STIRE COUNCIL	APPRIOACH SLAB - REINFORCEMENT
7.7					ORIGINAL COPY ON FILE	_	pitt&sherry	PROJECT	
-25					"e" SIGNED BY		pittasiiciiy	VAUGHAN-TARILTA ROAD	
- 53					_				DATUMS: CLIENT No.
4/8/2					=		pittsh.com.au Phone 1300 748 874 ABN 67 140 184 309	BRIDGE	AHD / MGA
ië.	B FOR TENDER	A.B.	M.A. I	3.S. 04/08/202	23 SIGNED	▼ Mount Alexander	© 2021 PITT & SHERRY (OPERATIONS) PTY LTD. THE DOCUMENT MAY	STATUS	DRAWING No. S-P.23.0690-00-STR-DRG-S315
ğ	A FOR APPROVAL	A.D.	M.A.	.W. 31/05/20	18	Shire Council	ONLY BE USED FOR THE PURPOSE FOR WHICH IT WAS COMMISSIONED AND IN ACCORDANCE WITH THE TERMS OF ENGAGEMENT	FOR TENDER	
ద					DATE	011110 000111011	AND IN ACCORDANCE WITH THE TERMS OF ENGAGEMENT.		Aug. 4, 23 - 12:47:06 Name: P.23.0690-00-STR-DRG-S315.dwg Updated By: Adrian Brunato