# Heathcote Civic Precinct

125 High Street, Heathcote 3523 VIC City of Greater Bendigo





Location Plan

Client Liason City of Greater Bendigo PO ox 733, Bendigo, Vic. 3552

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			Current			
Drawing Number	Drawing Title	Revision Date	Revision	Sheet Size	Checked By	Drawn By
TP-001	Cover Page	1/11/2024	D	A1	RH	DW
TP-101	Existing Site Plan	1/11/2024	D	A1	RH	DW
TP-201	Existing and Demolition Floor Plan	1/11/2024	D	A1	RH	DW
TP-202	Proposed Floor Plan	1/11/2024	E	A1	RH	DW
TP-203	Existing and Demolition Roof Plan	1/11/2024	D	A1	RH	DW
TP-204	Proposed Roof Plan	1/11/2024	D	A1	RH	DW
TP-301	Ex. & Demo. Reflected Ceiling Plan	1/11/2024	A	A1	RH	DG
TP-302	Proposed Reflected Ceiling Plan	1/11/2024	A	A1	RH	DG
TP-401	Existing and Demolition Elevations	1/11/2024	D	A1	RH	DW
TP-402	Proposed Elevations	1/11/2024	D	A1	RH	DW
TP-403	Photos	1/11/2024	D	A1	RH	DW
TP-404	Photos	1/11/2024 -	-	A1	RH	DW
TP-405	Photos	1/11/2024 -	_	A1	RH	DW
TP-406	Photos	1/11/2024 -	-	A1	RH	DW
TP-407	Photos	1/11/2024 -	-	A1	RH	DW
TP-408	Photos	1/11/2024 -	-	A1	RH	DW
TP-501	Ex. & Demo. Sections	1/11/2024	A	A1	RH	DG
TP-502	Proposed Sections	1/11/2024	A	A1	RH	DG
TP-901	3D	1/11/2024	D	A1	RH	DW
TP-902	3D	1/11/2024	С	A1	RH	DW

**Town Planning** 

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Draft Heritage Victoria Permit - Issues for Heritage Victoria Permit Set Issue to Lincoln Pearce Reissue to Heritage Vic Heritage Victoria Permit - Updated addition scope

14/08/2024

22/08/2024

06/09/2024

04/10/2024


1/11/2024

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client name City of Greater Bendigo



D

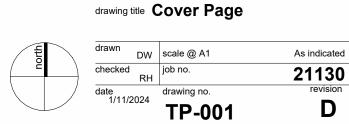

Existing Site Plan
scale 1:200

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no. revision note
Draft Heritage Victoria Permit - Issues for comment
Heritage Victoria Permit Set 22/08/2024
Issue to Lincoln Pearce 06/09/2024
Reissue to Heritage Vic
Heritage Victoria Permit - Updated addition scope 1/11/2024

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project name Heathcote Civic Precinct

client name City of Greater Bendigo

project address 125 High Street, Heathcote 3523 VIC


drawing title Existing Site Plan

 drawn
 DW
 scale @ A1
 1 : 200

 checked
 RH
 job no.
 21130

 date
 drawing no.
 revision

 TP-101
 D

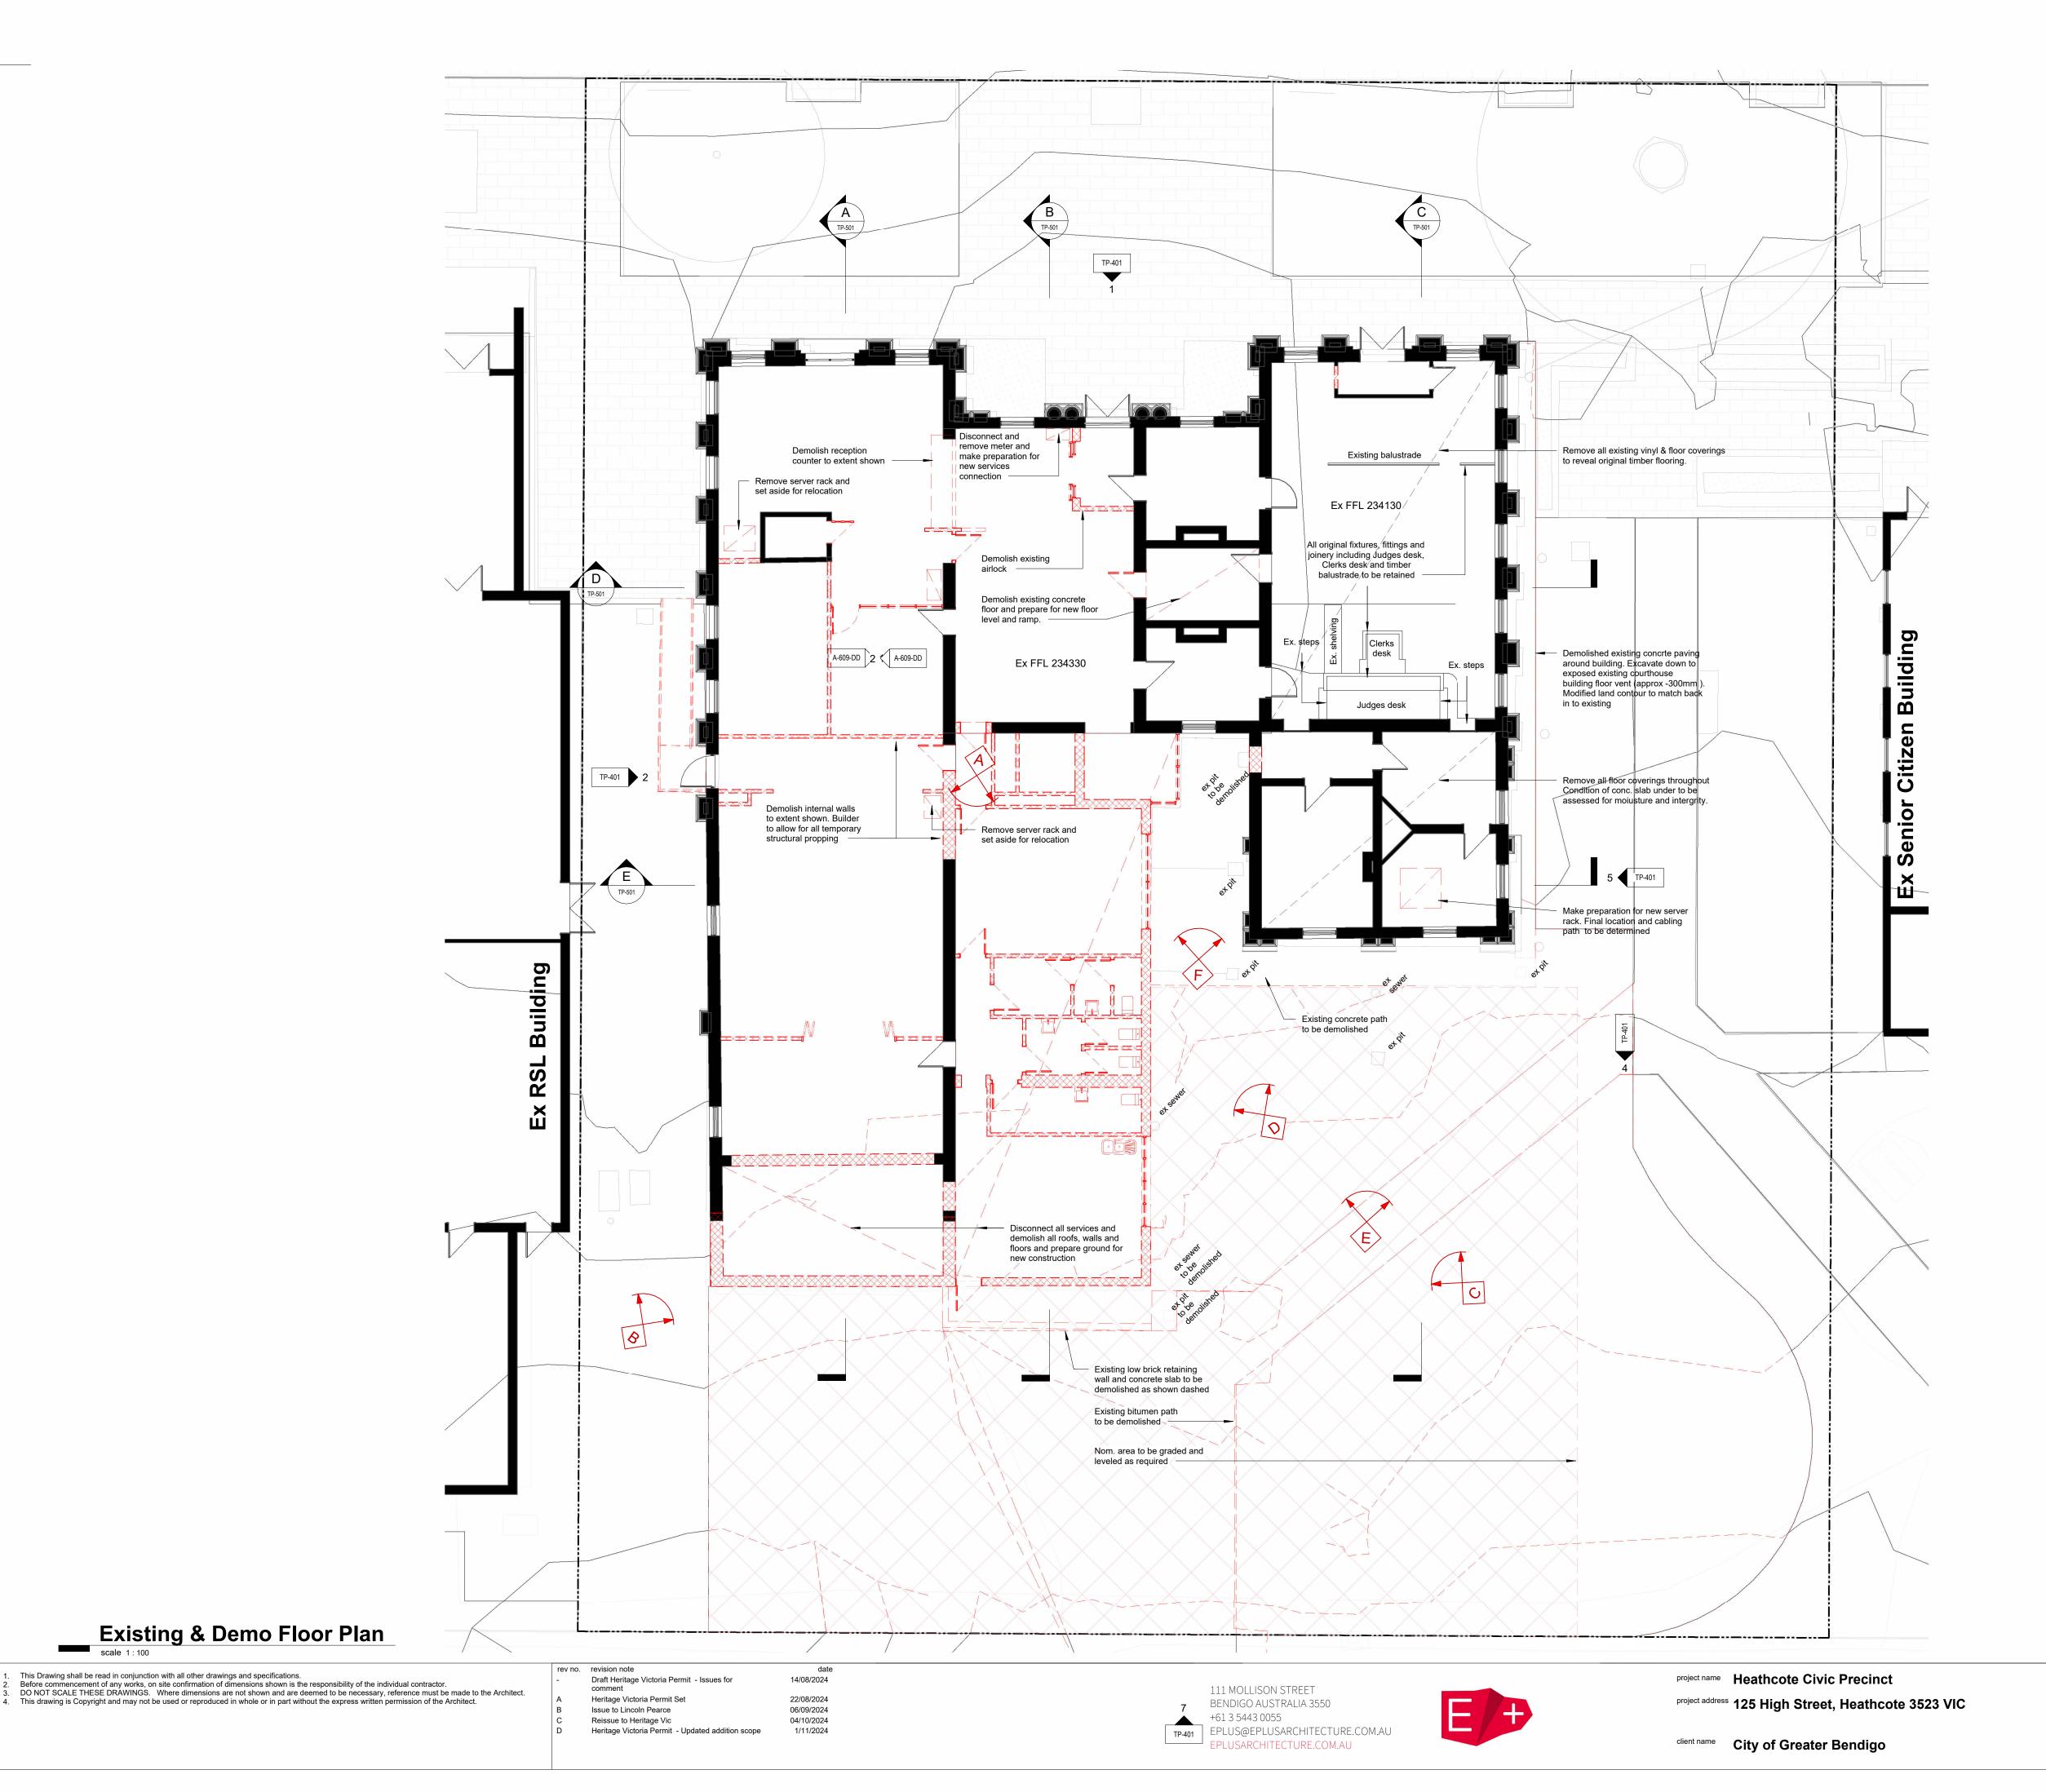

#### **Demolition general notes**

#### All items to be demolished shown dashed

Demolition of Structures

- Existing walls shown dashed red are to be demolished. 1. Dimensions relating to extent of demolition are indicative only & the contractor must verify locations of all existing & proposed services, walls, floors etc. prior to commencement of any work &
- to report discrepancies to the architect for resolution. 2. All materials and work practices shall comply with, but not limited to, the Building Regulations 2018, the National Construction Code Series 2019 & all relevant current Australian standards. These specifications specify only the minimum standard of work for the demolition works, & all workmanship & precautions shall be to best trade practice. Precautions must be taken before and

during demolition in accordance with AS 2601- 2001. The

- 3. During the progress of the demolition the works shall be under the continuous supervision of the Demolisher and demolition shall be executed by commencing at the roof & working downward. The demolition must not be commenced until the precautionary measures have been inspected & approved by the Relevant Building Surveyor.
- 4. All practicable precautions shall be taken to avoid danger from collapse of a building when any part of a framed or partly framed building is removed or where nearby earthworks are undertaken.
- 5. Demolish walls, structures & any other associated components shown dashed red and make good all adjacent surfaces as required. Demolish all walls to full height unless otherwise noted. Contractor to set up temporary propping/bracing prior to carrying out demolition of all existing load bearing walls/structures as required to engineer's details.
- 6. Junctions between demolished areas & surrounding floors, walls & ceilings to be neatly cut with a true face left on materials to be retained. Make good all surfaces affected by the demolition work
- to match adjacent existing surfaces.
  7. Remove all doors and windows shown dotted, including frames and architraves. Make good all adjacent surfaces as required. All created wall openings are to be boarded/ sealed to ensure no
- 8. Demolish all joinery and associated plumbing and electrical fittings and fixtures as indicated. Remove all fixtures on walls.

access is possible.

- 9. Demolish internal floor coverings and underlay to all areas. Remove any loose residual material or adhesive so as to achieve a level and sound base for new flooring.
- 10. Cut, remove & seal any existing electrical wiring, conduits & fittings, mechanical, water, sewer & gas service pipes & fixtures as required. Carry out in accordance with the relevant authorities approval & instructions.
- 11. Demolish all staircases & ramps shown red-dashed and make good all adjacent surfaces affected by the demolition work as required. Contractor to set up temporary propping prior to carrying out demolition as required to engineer's details. Any created floor voids or fall hazards to be boarded/sealed/barricaded as required
- 12. Assess retained roof structures & make good or replace with new in acc. with Structural Engineer's details. Protect & retain in situ all original roof vents TYP.
- 13. Protective outriggers, fences, awnings, hoarding, barricades and the like must be installed where necessary to guard against danger to life or property or when required by the Relevant Building Surveyor.
- 14. Salvage materials to be retained if possible & client to have first option of salvaged materials. Discuss with Client prior to removal on site. Remove and dispose all demolished materials and rubbish from the site unless specified or directed otherwise.
- 15. Dust creating material, unless thoroughly dampened down, shall not be thrown or dropped from the building but shall be lowered by hoisting apparatus or removed by material chutes.

16. Where possible, protect & retain on-site for possible re-use any

removed bricks & external pavers during demolition works. **Services Demolition:** 

demolition of services

### **Asbestos General Notes:**

- 1. Prior to commencing works, builder is to engage a specialist consultant to identify asbestos,& other hazardous material on the site. The consultant is to produce a written report detailing any hazardous materials identified incompliance with applicable laws and regulations. Upon receipt of this report, the builder is to submit a cost for the removal and proper disposal of any hazardous materials to the Architect for approval, prior to commencing works.
- 2. In the case that asbestos may be uncovered on site during demolition the contractor is to cease work immediately and advise the superintendent upon discovery of undocumented
- 3. Removal to be in strict accordance with the National Code of Practice for the safe removal of asbestos


Refer Drawing TP-201 for photo point location Refer Drawing TP-403 for photo detail




### **Town Planning**

drawing title **Existing and Demolition** Floor Plan

1:100 21130 drawing no. D

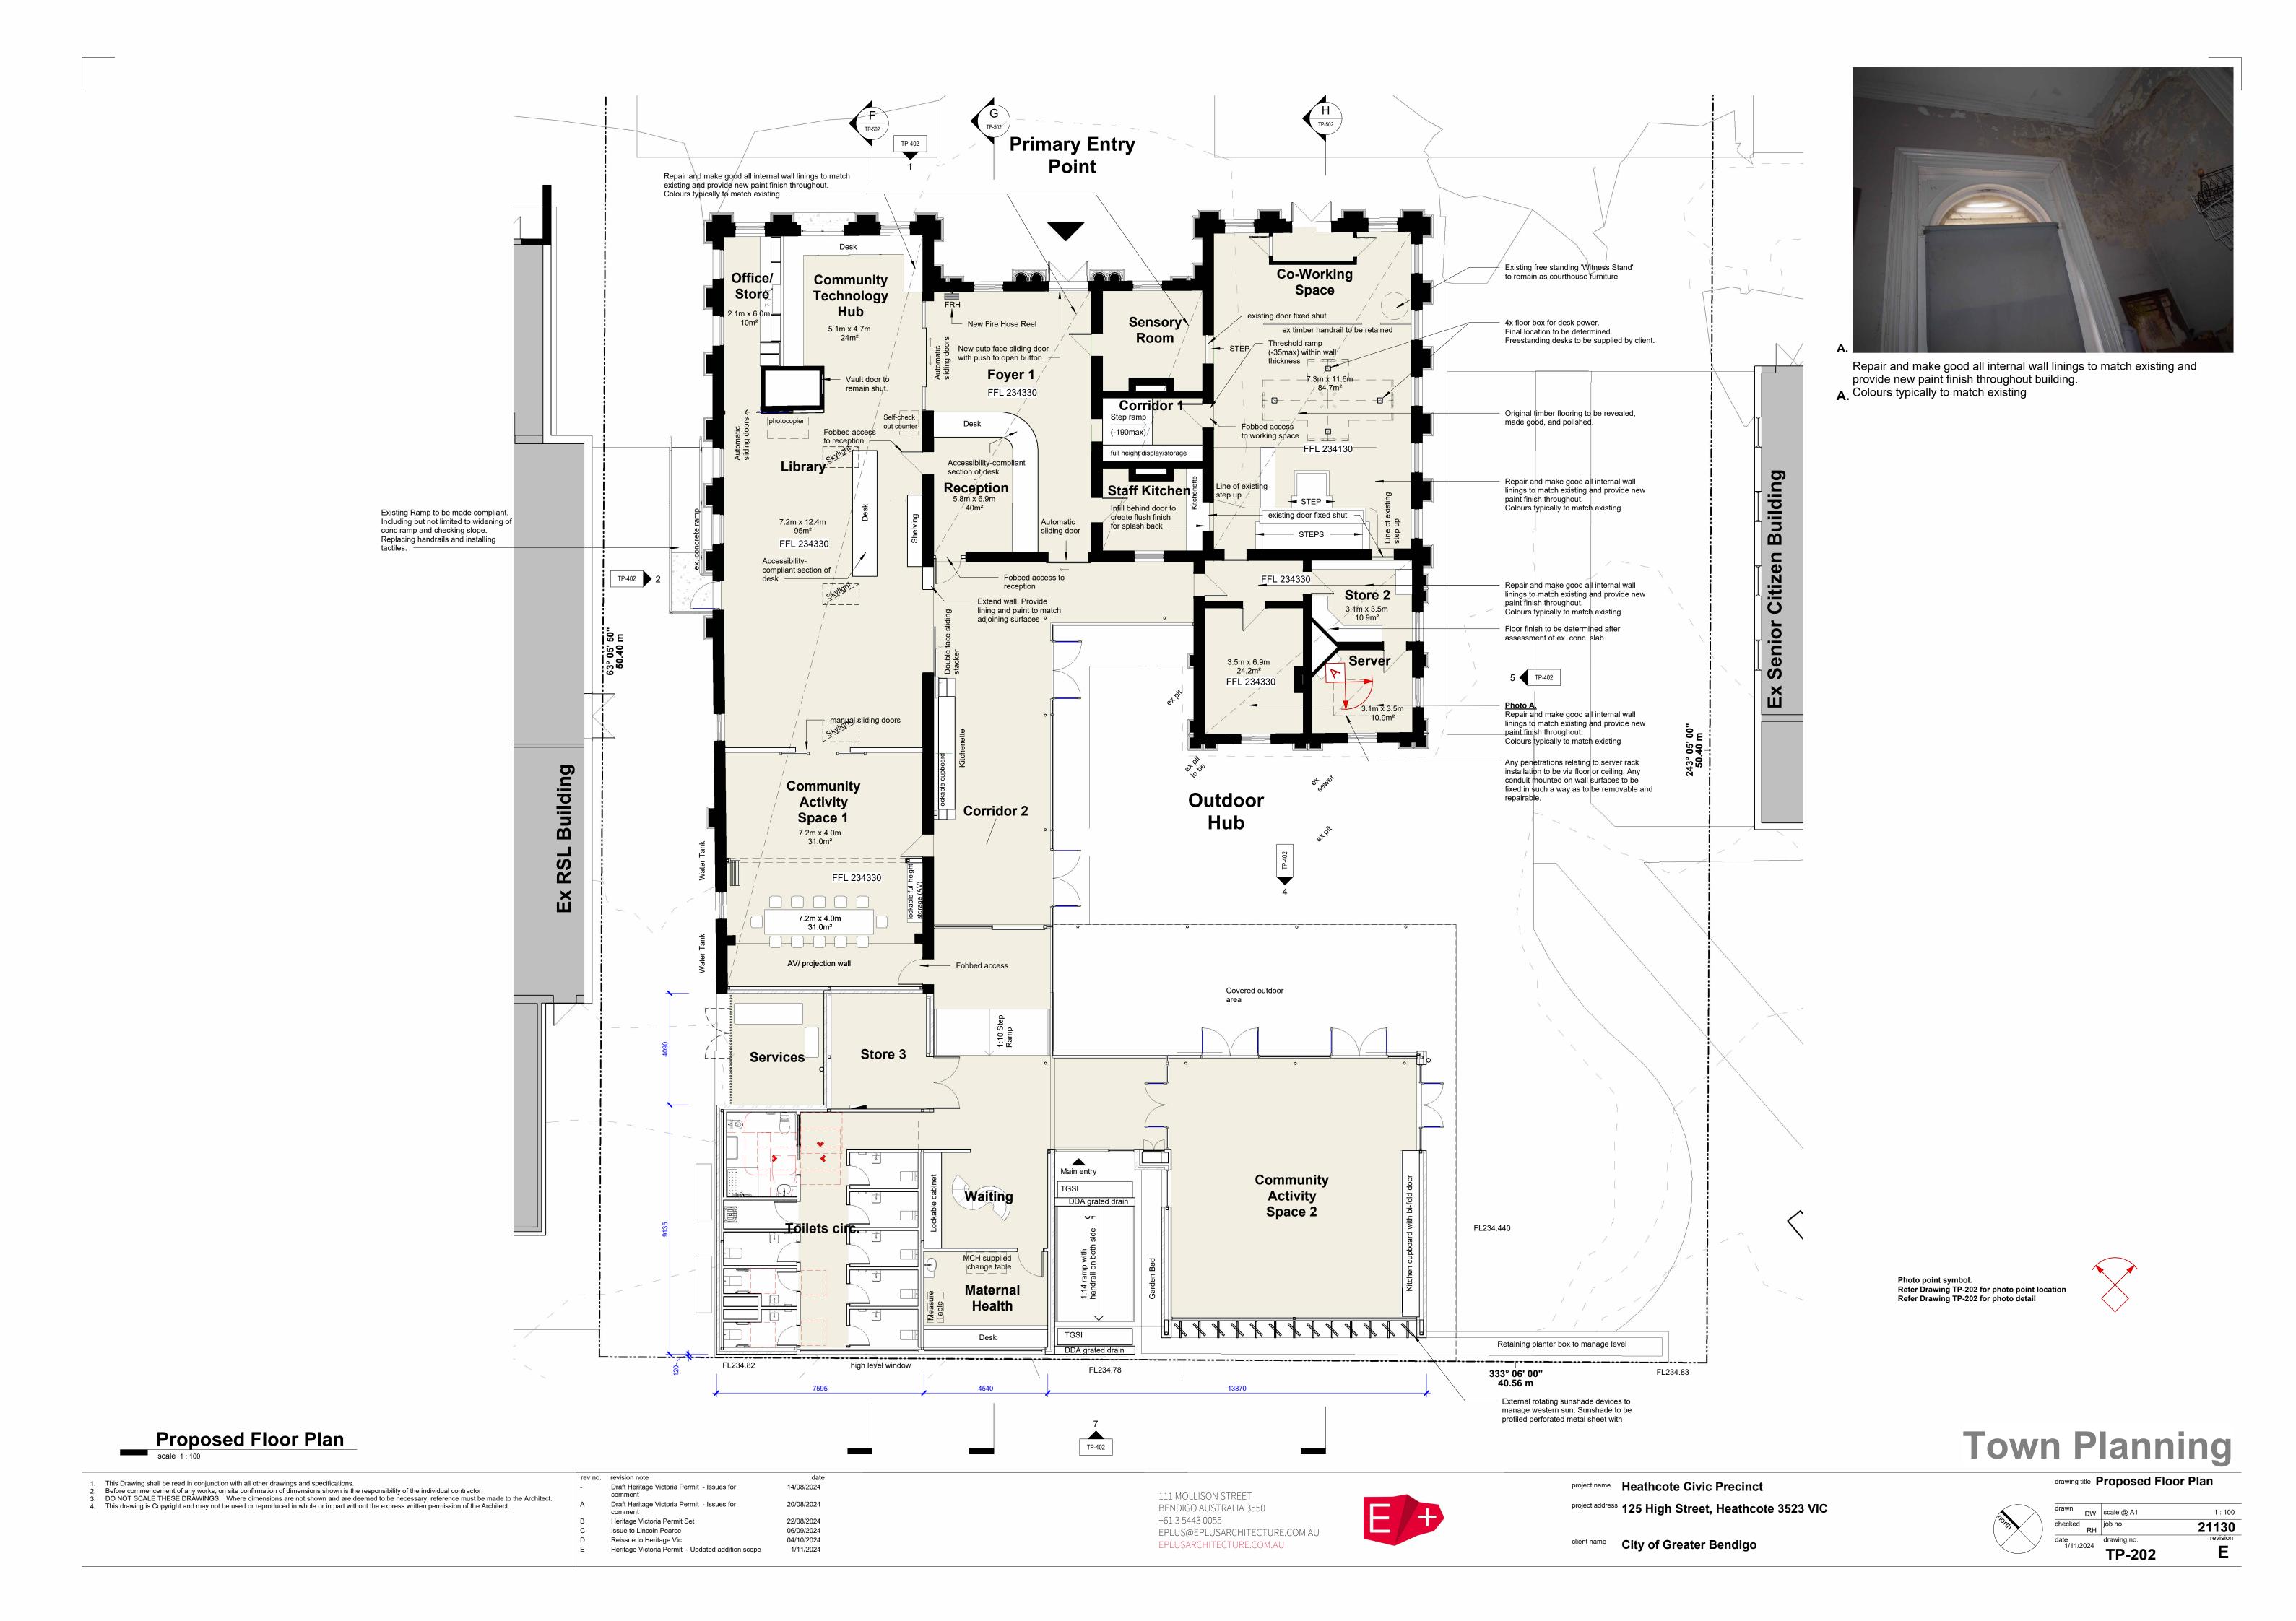

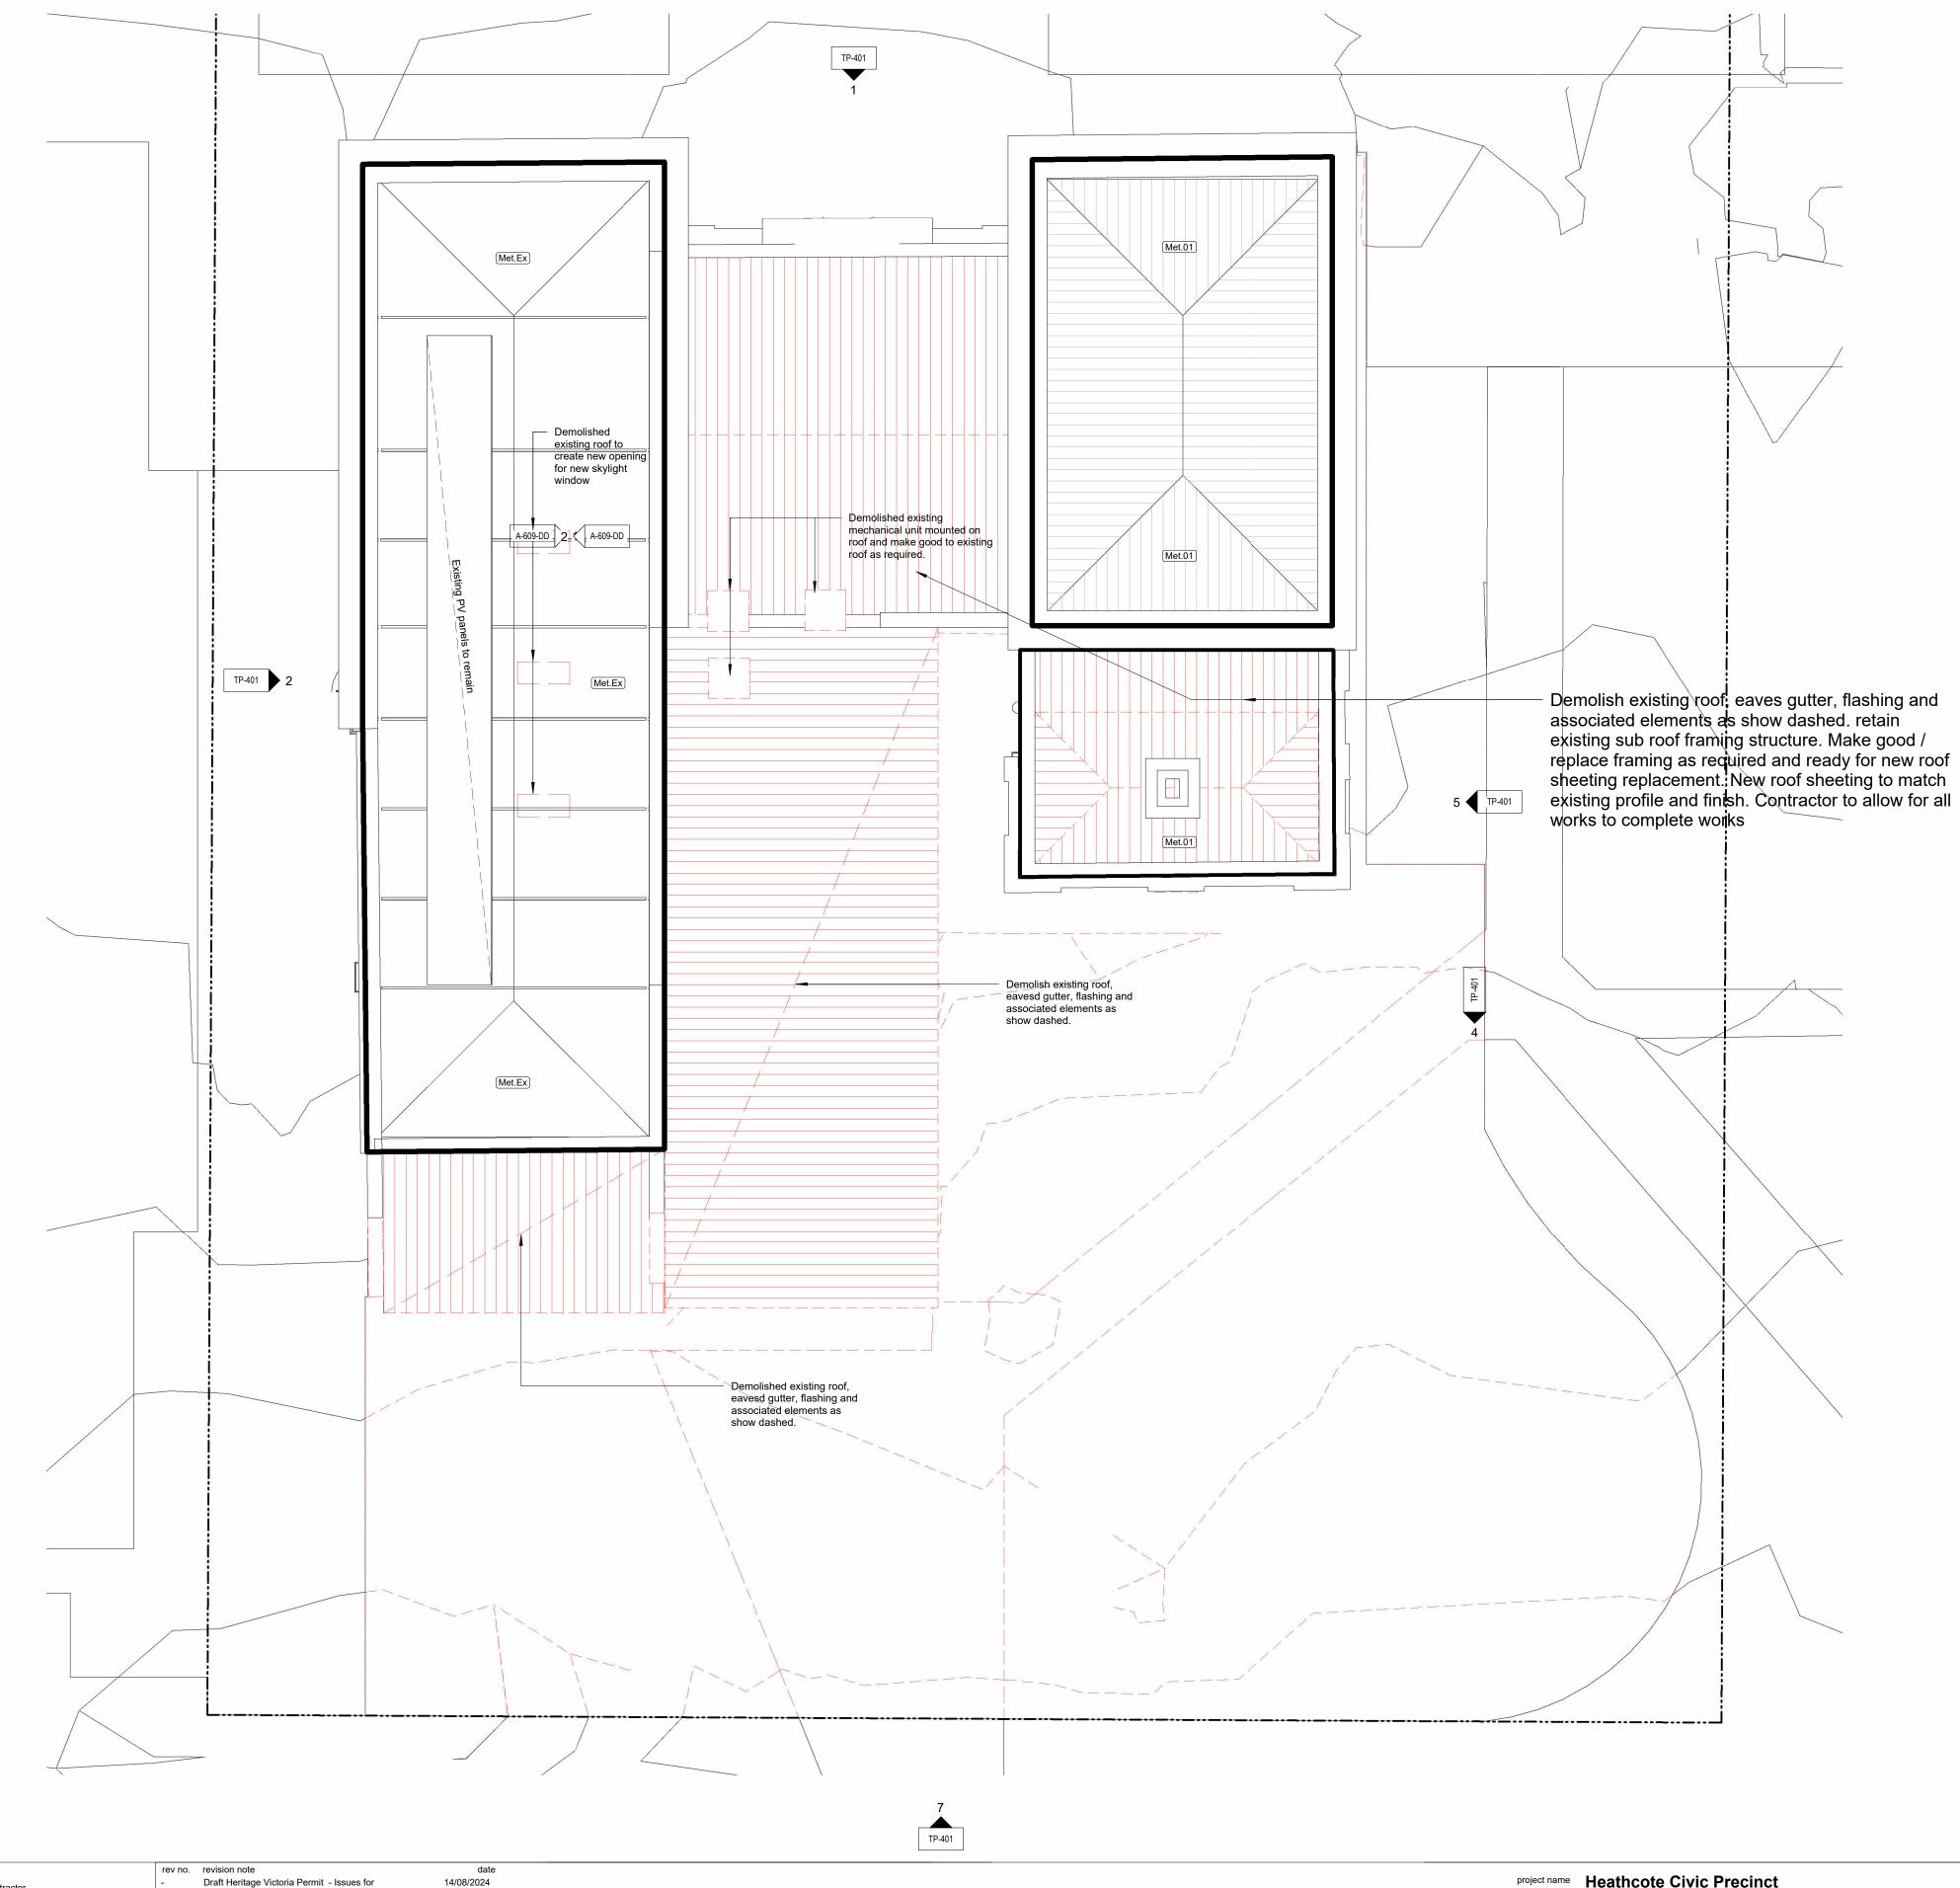

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- for safety.
  12. Assess retained roof structures & make good or replace with new in acc. with Structural Engineer's details. Protect & retain in situ all original roof vents TYP.
- 13. Protective outriggers, fences, awnings, hoarding, barricades and the like must be installed where necessary to guard against danger to life or property or when required by the Relevant Building Surveyor.
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#### **Services Demolition:**

demolition of services

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#### **External Finishes Legend**

Graphic	Code	Description	
	(Met.Ex	Existing metal roof cladding	
	Met.01	Metal roof cladding Refer schedules for material specification	
	(Met.02)	Metal roof cladding Refer schedules for material specification	
	(Bri.Ex	Existing brick face finish	
	(Mas.Ex	Existing rendered masonry finish	
	Bri.01	Selected new brick finish Refer schedules for material specification	
25 2 2 2 2 2 2 2 2 2 2 2 2 2 2 2 2 2 2	Fcs.01	Selected fibre cement sheet Refer schedules for material specification	

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**Existing & Demo Roof Plan** 

Draft Heritage Victoria Permit - Issues for Heritage Victoria Permit Set Issue to Lincoln Pearce Reissue to Heritage Vic Heritage Victoria Permit - Updated addition scope

22/08/2024

06/09/2024

04/10/2024

1/11/2024

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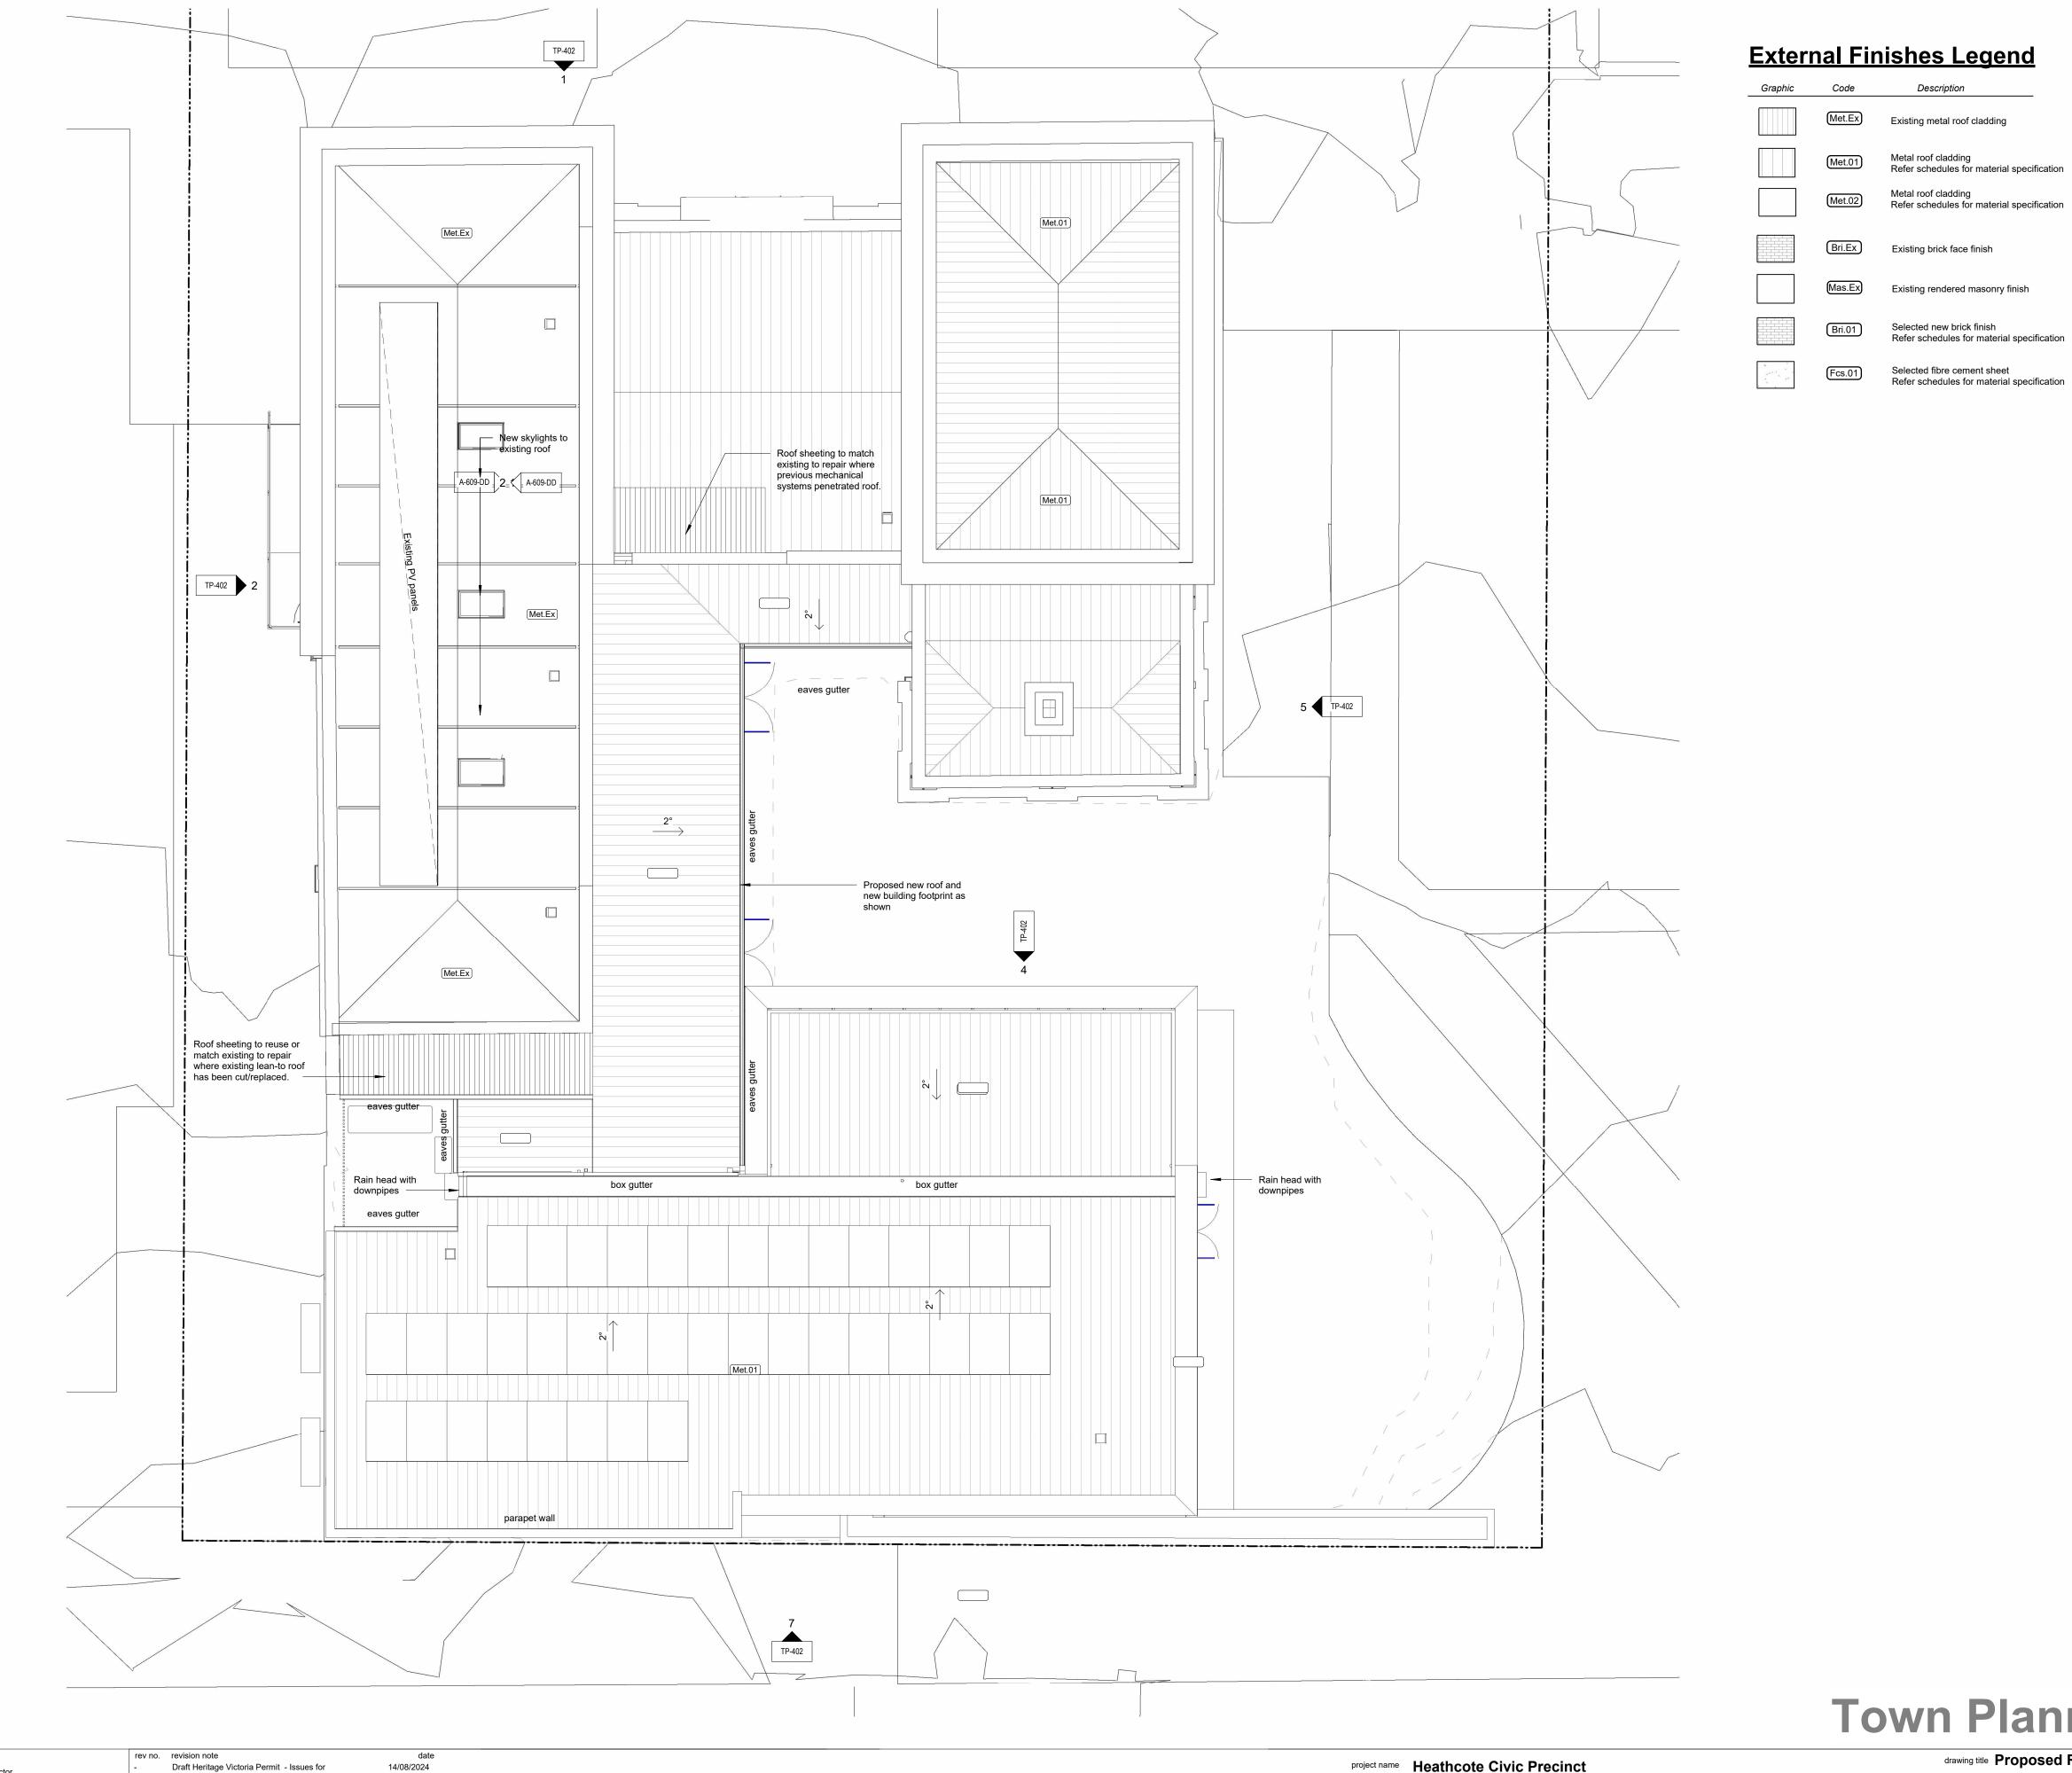
**Project name** Heathcote Civic Precinct

project address 125 High Street, Heathcote 3523 VIC

client name City of Greater Bendigo

drawing title **Existing and Demolition** 

**Roof Plan** 1:100 21130 D



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Proposed Roof Plan
scale 1:100

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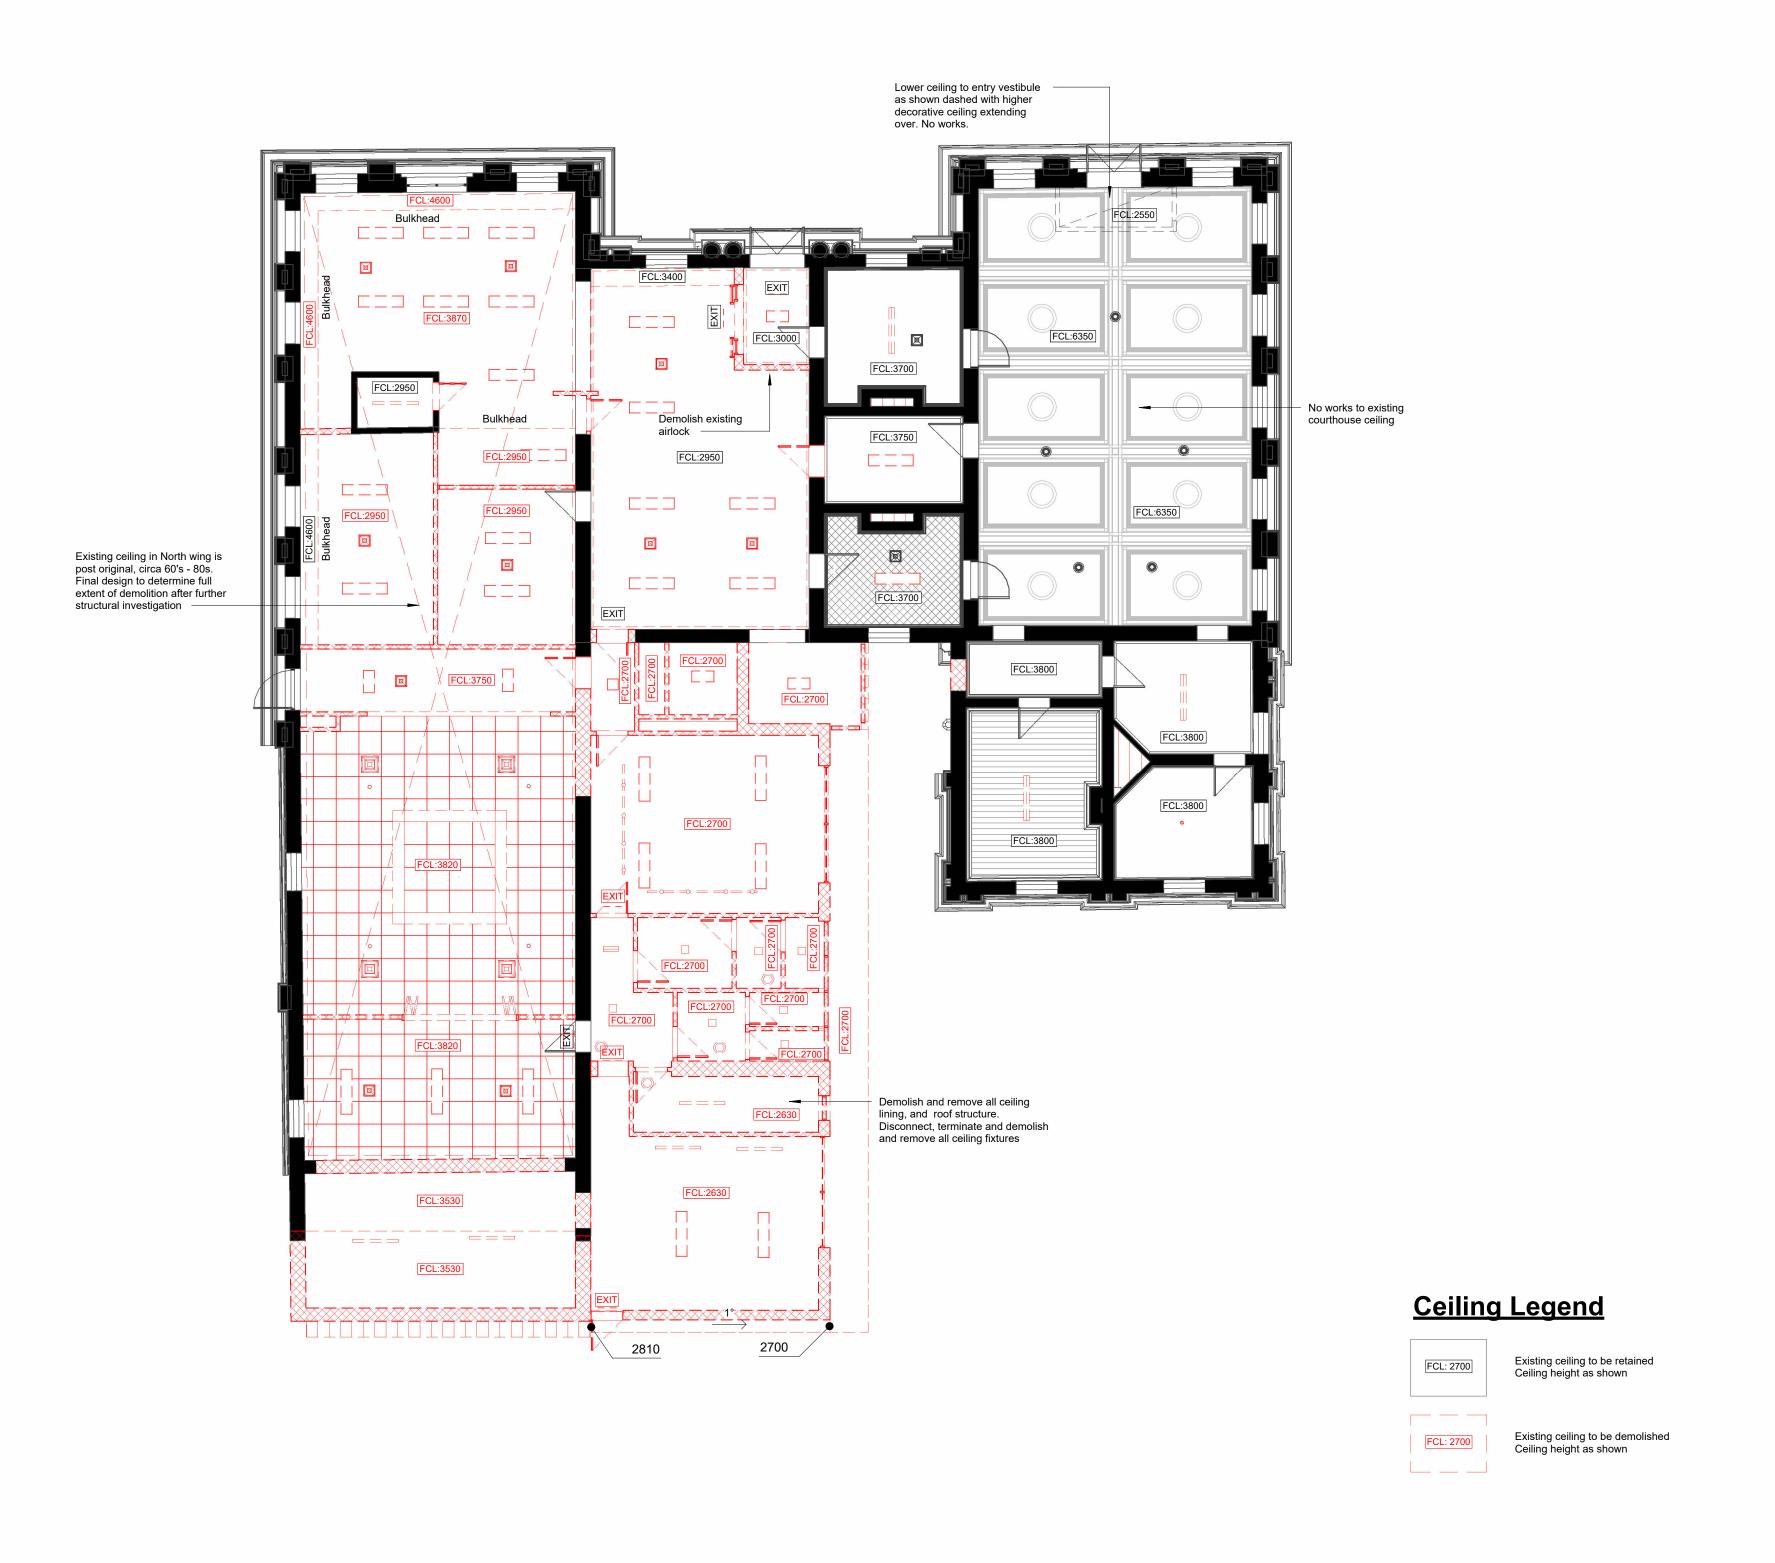
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project name Heathcote Civic Precinct project address 125 High Street, Heathcote 3523 VIC client name City of Greater Bendigo

**Town Planning** drawing title Proposed Roof Plan

1:100 21130 revision D



### Ex. & Demo. Reflected Ceiling Plan scale 1:100

# **Town Planning**

04/10/2024

client name City of Greater Bendigo



# **Town Planning**

04/10/2024

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drawing no.

**TP-302** 

1:100

A

21130

