#### **GENERAL NOTES**

- The Builder shall verify all dimensions and levels on site prior to commencement of work.
- 2 The Builder is responsible for locating all existing services before any demolition or building works commence, consult relevant authority and consulting engineer's drawings for details.
- The builder is responsible to check and verify all title boundaries, dimensions and levels on site before commencement of any works.
- Figured dimensions take precedence over scaled dimensions, do not scale from these drawings.
- 5 The smoke and spread of flame indices for all non exempt materials used in the Building are to be provided in accordance with specification C1.10 of the **Building Code of Australia.**
- All doors leading to exits and in exits are to be fitted with door furniture mounted between 900mm and 1100mm above floor level and be capable of being opened without the use of a key from the direction which a person would seek egress, by a single-handed downward action on a single device.
- All glass shall comply with AS 1288 and AS 2047 Selection and installation of Windows, glass shall comply with the relevant Section J Report. All full height glass panels in windows and doors shall have an approved vision strip installed not less than 900mm above floor level.
- All works shall be carried out in accordance with the **Town Planning / Development Approval conditions,** endorsed drawings and documents.
- All materials and workmanship shall comply with the relevant Australian Standard Codes and current National **Construction Code.**
- 10 Builder to provide all necessary protection and hoarding to existing and adjoining properties and or buildings as is required to carry out the works. Confirm with the Local Authority Hoarding and Access requirements and
- All wall thickness shown as dimensions are taken from face of structural framing. Interior and exterior wall linings and finishes are not included unless noted.
- 12 Make good, repair or replace as required all existing surfaces disturbed by new works to match existing or as specified by Builder.
- 13 Supply and install fire extinguishers and associated signage in accordance with the relevant Australian Standard and with the requirements of the Statutory Authority having jurisdiction.
- unless otherwise specified. Refer to finishes schedule for all floor finishes. Maintain finished levels across changes of floor finish. Install floor finish dividers as specified where changes of floor finishes occur. Architectural slab set-out plan shall be used to set-out building perimeter, slab set-downs and rebates. Locations of intermediate floor beams are indicative only and should be checked and co-ordinated with the structural engineer's drawings and documentation. Locations of penetrations for waste

water services, electrical and the like are indicative only

14 Levels shown on slab plan refers to structural floor level

15 Allow for packing of walls as required to maintain a same plane wall sheeting. Contractor to allow for packing of stud walls to allow for fixing of sanitary fittings and fixtures, grab-rails, handrails, light fittings, joinery and the like.

and shall be used as a guide and general reference

purposes only and shall be co-coordinated with the

relevant Services Engineers drawings.

- 16 All DP's, sewer stacks, floor wastes etc. running internally in ducts/bulkheads to have acoustic pipe lagging (deci-mate 5-25 system or equal). Enclosures to have 2 x 13mm thick lining toward usable space and 90mm bulk insulation.
- 17 All stair risers and treads shall comply with currant NCC and Australian Standards, the Builder shall make allowance for floor finishes when setting out risers, no variations in riser height shall be permitted as specified by the Building Code of Australia or Australian Standard.
- 18 All internal and external ramps shall have a maximum gradient of 1 in 14 with a maximum crossfall of 1 in 40, a minimum clear width of 1000mm.
- 19 All handrails, balustrades, and grab-rails shall be installed to comply with the current building code of Australia and to AS1428.1 current version.
- 20 Accessible sanitary facilities ( disabled ) and ambulant sanitary facilities shall be constructed in accordance with the plans, elevations and details, they shall comply with AS1428.1 current version, all fixtures and fittings shall be accessible compliant.
- 21 All paving and site levels shown on architectural floor plans and site plans are for DDA compliance and approval- levels shall be co-coordinated between architectural and civil engineer's drawings. Report all errors, omissions, conflicts and discrepancies to Mt Martha Design + Drafting.
- 22 Locations of all penetrations through concrete floor slab and shown on slab set-out plan shall be checked and confirmed on site by Drainage Contractor in consultation and co-ordination with any Service Engineer's drawings and details.
- 23 All toilet and way finding signage shall comply the current NCC and current AS1428.1. Provide signage on all Ambulant Toilet cubicles, Accessible Toilets and the like.

#### **BUILDING AND STANDARDS REFERENCE**

All references contained within these standard notes and warnings which refer to the Building Code of Australia or the Australian Standards or to any Local Authority by-law shall mean the most recent amendment or version of such code or standard. It is the contractors responsibility to ensure that all trades and sub-contractors are aware of the NCC and Australian Standards relevant to their area.

#### DIMENSIONS EXISTING CONDITIONS

All dimensions shall be checked on site, dimensions shown are nominal and shall be used as a guide.

#### WATERPROOFING AND **GRADED BATHROOM FLOOR**

All bathroom / shower floor grades shall be in accordance with AS1428.1 - 2009 Section 15, Cause 15.5.2 floor and waste outlet which states the following;

- a. The floor of the shower recess and associated circulation space shall be self draining and without a step down, raised step, kerb or hob at the entry to the recess
- b. The waste outlet for the shower shall be provided in accordance with Fig 47 AS 1428.1-2009
- c. The slope of the floor of the shower recess shall have a gradient between 1 in 60 and 1 in 80 as shown in Fig 49 as 1428.1-2009
- d. The slope of floor of the remainder of the sanitary facility shall have a gradient between 1 in 80 and 1 in 100 as shown in Fig 49 as 1428.1-2009.
- e. Provide a waterstop to any perimeter opening to the An accredited waterproof membrane must be installed to the entire wet area including a minimum of
- 25mm to walls above the finished floor surface. An accredited waterproof membrane must be installed at least 1500mm clear horizontal distance from the shower rose.

#### STANDARD GENERAL ABBREVIATIONS

AF	ACCESS FLOOR		
AF AP	ACCESS PLOOR ACCESS PANEL	LT	LIFTING TRACK
AL	ALUMINIUM FRAME	LAM	PLASTIC LAMINATE
AW	AWNING WINDOW	LVP	LOUVRE PANEL
ADJ	ADJUSTABLE SHELVING	LS	LIGHT SWITCH
B BJT	BENCH BUTT JOINT	LVR	LOUVRES
BR	BRICKWORK	LVM MT	LOUVRES TO WINDOWS MIXER TAP
BK	BLOCKWORK	MR	MIRROR
CBD	CUPBOARD	MSSB	MAIN SITE SWITCHBOARD
CHS	CIRCULAR HOLLOW SECTION	MSB	MECHANICAL SWITCHBOARD
CL	CEILING LEVEL	MW	MICROWAVE
CFC COS	COMPRESSED CEMENT SHEET CHECK ON SITE	O/F	OVERFLOW OFFICER BUYOT
CG	CORNER GUARD	OP OS	OFFSET PIVOT OPENABLE SASH
CH	COAT HOOK	OHC	OVERHEAD CUPBOARD
CP	CARPET (BROADLOOM)	OHS	OVERHEAD SHELVES
CT	CARPET TILE	OPW	OPERABLE WALL
CS CSD	CLEANERS SINK CAVITY SLIDING DOOR	OV	OVEN
COL	COLUMN STRUCTURAL	PA PC	PUBLIC ADDRESS SYSTEM PRECAST CONCRETE PANEL
DP	DOWNPIPE	PJ	PRECAST JOINT
DJ	DUMMY JOINT	PV	PAVING
DCL	DOOR CLOSER	PIN	PINBOARD
DL	DOWNLIGHT	PB	PLASTERBOARD
DRW DW	DRAWER DISHWASHER	PEN PTD	PENDANT LIGHT FITTING PAPER TOWEL DISPENSOR
DW	DOUBLE HUNG	R	ROBE
DFN	DRINKING FOUNTAIN	RW	RAINWATER TANK
DM	DOOR MAT	RM	ROOM
EA	EQUAL ANGLE	RE	RESILIENT FLOOR FINISHES
EH	ELECTRICAL HEATER	RSD	ROLLER SHUTTER DOOR
EJ EMB	EXPANSION JOINT ELECTRICAL METER BOX	RHS REF	RECTANGULAR HOLLOW SECTION REFRIGERATOR
EQ	EQUAL	SEC	SECURITY PANEL
EX	EXISTING	SCJ	SAW CUT JOINT
EXF	EXHAUST FAN UNIT	SS	STAINLESS STEEL SINK
EMG	EMERGENCY LIGHT FITTING	SHT	SHOWER SEAT
FG FA	FIXED GLAZING FALL ARREST FLUSH BOLT	SD	SLIDING DOOR SHELF
FB	FLUSH BOLT		SHOWER CURTAIN
re .	FIRE EXTINGUISHER	SHW	
FH	FIRE HYDRANT	SWB	SWITCHBOARD
	FLUSH PULL	SIGN	
	FIXED SHELVES FIRE HOSE REEL	SL	SKYLIGHT
		SW	SLIDING WINDOW SLIDING DOOR
FN	FENCING	SD SHS	SQUARE HOLLOW SECTION
	FABRIC	ST	STONE TILE
			STONE CLADDING
FVV FS			STONE FLOORING
			SOLID SURFACE SPLASHBACK
GAS	GAS METER		SMOKE DETECTOR
GU	GUARDRAIL		SPRINKLER HEAD
GR	GRAB RAIL	TM TV	TIMBER
GL	GROUND LINE	TV	TELEVISION TOILET ROLL HOLDER
GS	POWER POINT GAS PANEL HEATER	TAC	TACTII F INDICATOR
GF	GLAZING FILM	TC	TEXTURED COATING
	GLAZING	TL	TOWEL RAIL
	GLASS BLOCK		TOILET PARTITIONS
GT	GAS COOKTOP		TROUGH
HR	HANDRAIL	IIRF	TOP HUNG
	HYDRONIC HEATING PANEL	UB	UNDER BENCH FRIDGE UNIVERSAL BEAM
HT	HOSE TAP	UR	URINAL
	HINGE		VISION STRIP
	HANDBASIN HEARING LOOP		VILLABOARD
			TOILET WALL HUNG BASIN
			WALL HUNG URINAL
HN			
	HOT WATER CYLINDER	WF	WALL FRAME
	HARD PLASTER INTERACTIVE WHITEBOARD	WL	WHITEBOARD WALL FRAME WALL LIGHT WORKSTATION WALL THE
	INSULATION THERMAL	WT	WALL TILE
J	JOINT	** 1	WIRELESS DATA POINT
KP	KICKPLATE	ZIP	BOILING WATER UNIT
<b>(C)</b> c	OPYRIGHT WARNING		

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#### STANDARD NOTES AND WARNINGS **GLASS USE WARNING**

Any and all glass which is laminated and contains either a coloured film to interior face or other method of applied colourization to glass shall be used with caution, due to differential expansion within the laminated glass component, being the interior panel of glass and the exterior panel of glass expand and contract at differing rates causing failure of the glass panel in certain circumstances, and temperature ranges. Glaziers and window manufacturers are to ensure laminated glass is not used where harm from panels falling and or breaking can cause injury to persons and or property. Use of such panels without consent and or approval shall become the sole responsibility of the Glazier and or window manufacturer and or both.

#### VISUAL INDICATORS

All windows and glazed doors shall be provided with visual indicators in accordance with AS1428.1-current

#### FIRE EXTINGUISHERS

Supply and install Fire Extinguishers and associated Signage in accordance with the relevant Australian Standard and with the requirements of the Statutory Authority having jurisdiction.

#### WALL SUPPORT NOTE

Builder shall allow for blocking of walls with either 12mm marine ply sheeting fixed flush with face of wall studs or with 140x45 Timber Noggins nailed between studs, blocking is required for all Grab Rails and other wall fixtures such as Hand Dryers, Basins, Rails and the like, also for light fittings. Co-ordinate location with internal elevations. If unsure of locations or extent refer to Manufacturer for placement instructions.

#### **ACCESS PANELS**

For all electrical and mechanical equipment located within ceiling space, provide a minimum 450x450mm min access panel adjacent equipment, extent and locations to be confirmed on site by Builder.

#### **EXPOSED STEELWORK**

All steelwork which includes all columns and beams if any which are exposed to weather and located externally shall be hot dipped Galvanised. Any site alterations to steelwork which compromises Galvanised finish shall be on site cold Galv finished.

#### **SLAB PENETRATIONS**

Locations of all floor wastes and services penetrations shown on slab layout plan are to be used as a guide only. Final locations to be checked and confirmed on site by **Drainage Contractor in consultation and co-ordination** with Service Engineer's drawings and details.

#### SANITARY FACILITIES WALLS

Where walls are part of sanitary amenities or wet areas such as Cleaners room or Laundries and Bathrooms, they shall be lined with 12mm villaboard or 13mm water resistant plasterboard as noted and/or nominated in material and finishes schedule to all internal wall faces to these sanitary compartments, amenities and disabled toilets.

All amenity walls shall have minimum 90mm bulk insulation between studs to all perimeter walls as shown on floor plans and details including external walls, provide wall blocking as noted.

#### FIRE PROTECTION

Fire resistance and construction requirements NCC Part C. All new penetrations through floors for services, pipework ductwork and the like shall be protected by means of a fire collar or mastic as appropriate access and egress NCC Part D. Storage spaces under stairs used for egress shall have a rating of 60/60/60 walls and ceiling, doors to such storage areas must be -/60/30 self closing fire door ( NCC D2.8 )

#### MOUNTING BRACKETS

Mounting brackets for televisions and other equipment are to be located outside the 2000mm head height clearance requirement along paths of travel.

#### **SLAB PENETRATIONS WARNING:**

New penetrations into existing suspended concrete floor slab shall have the area under the slab checked for existing services, final locations to be approved by the Structural Engineer, all penetration sizes shall be kept to a minimum required. No coring shall commence until such time as location and determination of structural slab has be determined and approved by Structural **Engineer and Building Management. Provide protection** to area affected by a basement carpark. Drilling may only be undertaken during the hours as directed by **Building Management** 

#### **ELECTRICAL FITTINGS RCP**

Note: for all electrical fittings refer to Electrical Engineer's drawings, light fittings shown on reflected ceiling plan are indicative only and shall be checked and confirmed with Builder prior to placement.

#### TERMITE PROTECTION

The Contractor shall note that these works are located with a designated termite area and as such physical termite barriers shall be installed to perimeter of all new buildings and to all penetrations into new building either from under floor or from outside the perimeter of the building. physical barriers such as "trithor and trithor collars" for penetrations shall be allowed for and installed in accordance with manufacturers details and specifications, all such termite barriers shall be installed by a qualified and trained installer.

### **LEGEND**

Denotes the location of smoke alarms to be provided and installed in accordance with as 3786 and unless installed in an existing part of a class 1, 2 or 3 or a class 4 part of a building, the smoke alarm shall be hard wired and each one to be interconnected and have battery backup.

> Denotes ceiling or wall exhaust fan installed in accordance with A.S. 1668.2 (linked to relative light switch). 25 litres/sec WC or bathroom air must be exhausted to

A. the outside air via way of ducts or

A05 PROPOSED INTERNAL ELEVATIONS

tiled without sarking.

into roof space provided it is adequately ventilated with roof vents and/or open eaves, or the roof is

DRAWING REGISTER No. PAGE TITLE GN-01 GENERAL NOTES GN-02 ACCESSIBILITY NOTES A01 PROPOSED LOCATION SITE PLAN EXISTING FLOOR PLAN PROPOSED FLOOR PLAN A03 PROPOSED INTERNAL ELEVATIONS






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DATE	AMENDMENT DESCRIPTION	ISSUE	Proposed Veranda & Deck Extension	1
			YMCA	
			Crown Allotment (4B) No. 35 Sunnyside Road,	
			Mt Eliza, Victoria	3930
			ATTENTION: These drawings may not be current or final issue. Look for the building permit approval stamp.  © COPPRIGHT WARNING This document is protected by federal copyright law. Copyring in any shape or form, in whole or in part, with restrictions it refuse hospholded Call deprending or change or remove or may be become be appoint.	



#### STAIRS AND RAMPS

Minimum clear width between stair handrails shall be no less than 1000mm, however to allow for movement of persons with disabilities no stair or ramp shall be less than 1200mm clear width between handrails.

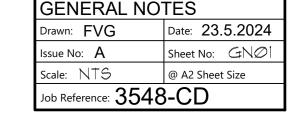Movement of persons with disabilities should be able to occur in a confident and consistent manner, all continuous accessible paths of travel will have a minimum clear unobstructed width of 1200mm, no items such as columns, fire hose reels, wall mounted telephones or any other item which would encroach on the clear width shall be permitted into the accessible path space.


For paths of travel less than 1800mm in clear width, passing areas of a width of 1800mm must be provided for a length of 2000mm every 20m as per AS 1428.1 - Clause 6.4

Handrails shall be provided to both sides of all stairs and ramps and be continuous around all landings with appropriate extensions, design and of consistent height.

Provide warning strips of not less than 50mm and not more than 75mm with a maximum of 10mm downturn on the tread nosing for the full width of the stair with a minimum luminance contrast of 30% to the background as per AS1428.1 - 2009 clause 11.1. Stair nosings shall not have an exposed vertical face of more than 10mm.


All stair risers shall be enclosed and shall not have an overhang, risers may be angled a maximum of 25mm to the vertical from the stair nosing to the rear of the tread.

Tactile ground surface indicators or a suitable barrier must be provided where there are impediments or hazards with less than 2000mm clearance head height. eg: under stairs and ramps as per AS1428.4.1-2009 Clause 2.6.

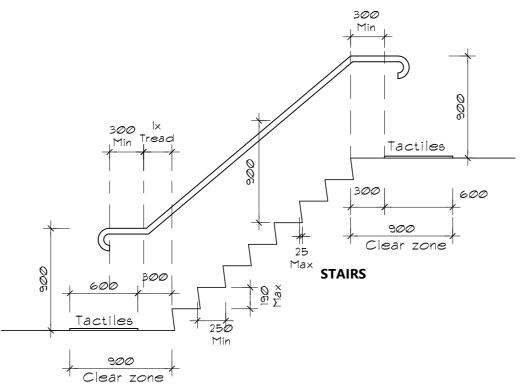


Note: Tactiles are required at start and end of flight of stairs, they are also required at landings if handrail is not continuous around landings.

TYPICAL STAIR SET-OUT

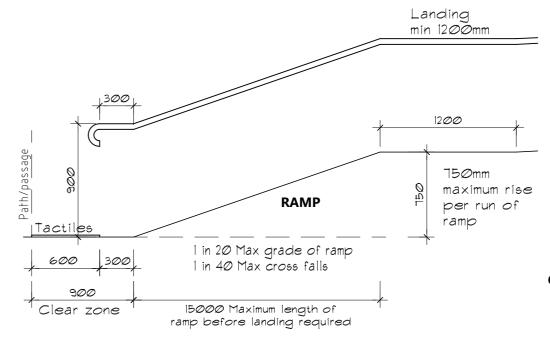

TYPICAL RAMP SET-OUT

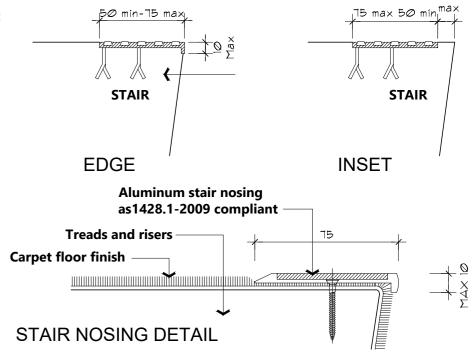

#### STAIR NOSINGS

Where rebated / recessed stair nosing are are required the Contractor shall ensure specified type is used. Where Contractor provides a substitute recessed / rebated tread nosing the Contractor shall seek approval from the Super-Intendant prior to purchase and installation of such nosing- where nosing is to be rebated into a selected tile floor finish the Contractor shall ensure that such rebate has no effect on the tile which may cause such tile to fracture or break due to excessive depth of rebate

GENERAL NOTES




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	DATE	AMENDMENT DESCRIPTION	ISSUE	Proposed Veranda & Deck Extension
				YMCA
				Crown Allotment (4B) No. 35 Sunnyside Road,
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9				ATTENTION: These drawings may not be current or final issue. Look for the building permit approval stamp.  (C) COPPRIGHT WARNING
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ACCESSIBILITY NOTES			
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Issue No: A	Sheet No: GNØ2		
Scale: NTS	@ A2 Sheet Size		
Job Reference: 354	8-CD		



#### SITE SURVEY GENERAL NOTES:-

HABITABLE WINDOW DIMENSIONS = 1200mm (Height) x 600mm (Width)

S = APPROX SILL HEIGHT ( mm ) ABOVE NATURAL GROUND LEVEL S=350

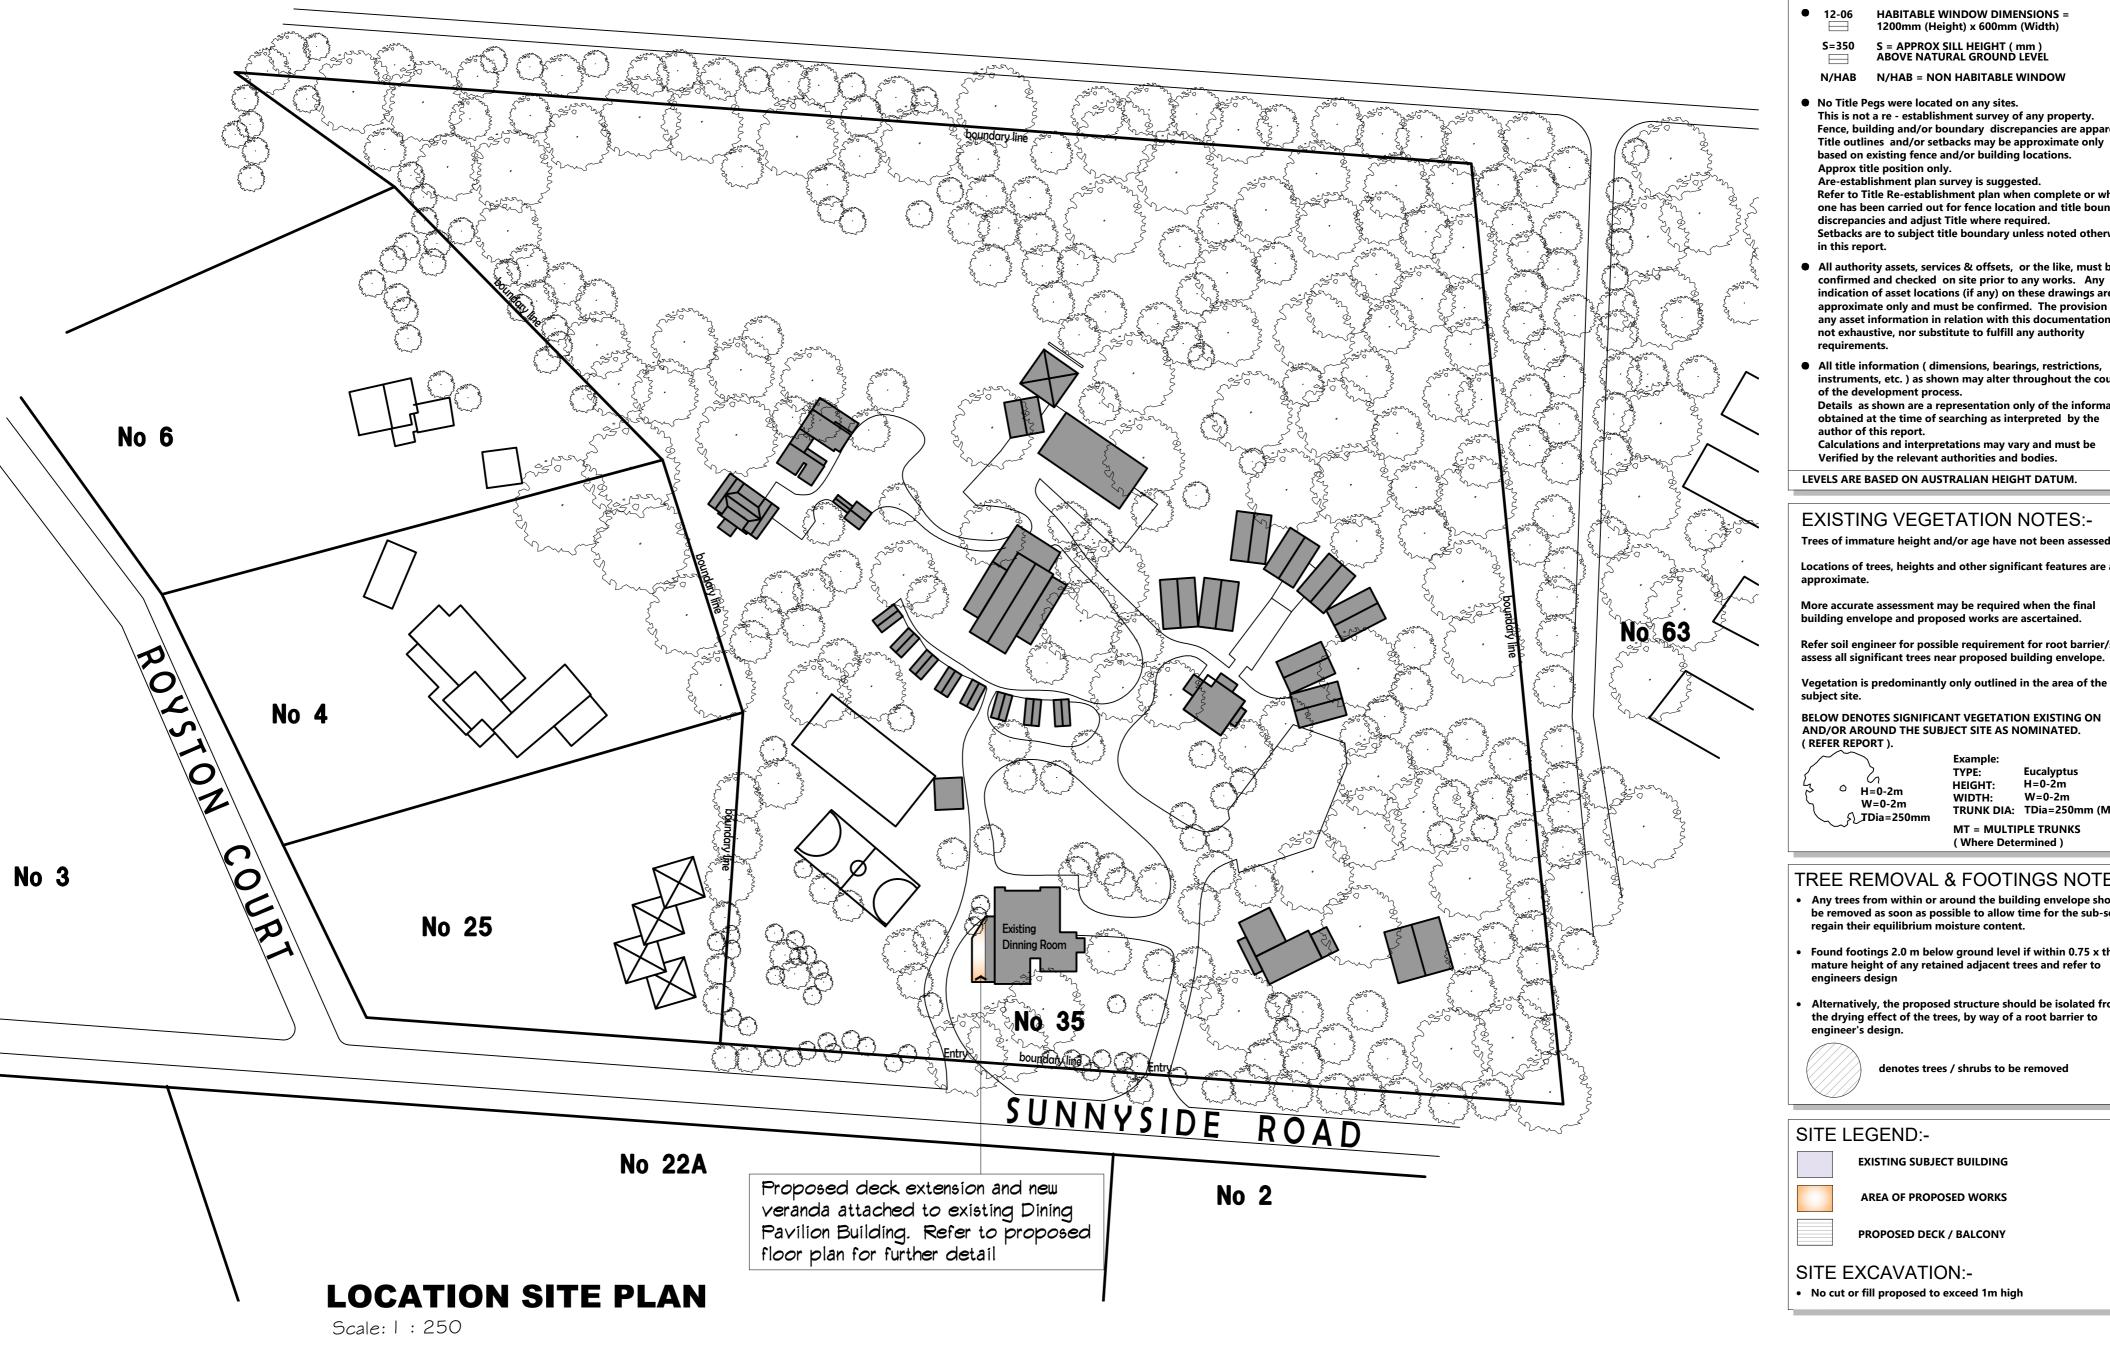N/HAB = NON HABITABLE WINDOW

 No Title Pegs were located on any sites. This is not a re - establishment survey of any property. Fence, building and/or boundary discrepancies are apparent. Title outlines and/or setbacks may be approximate only based on existing fence and/or building locations. Approx title position only.

Are-establishment plan survey is suggested. Refer to Title Re-establishment plan when complete or where one has been carried out for fence location and title boundary discrepancies and adjust Title where required. Setbacks are to subject title boundary unless noted otherwise in this report.

- All authority assets, services & offsets, or the like, must be confirmed and checked on site prior to any works. Any indication of asset locations (if any) on these drawings are approximate only and must be confirmed. The provision of any asset information in relation with this documentation is not exhaustive, nor substitute to fulfill any authority
- All title information ( dimensions, bearings, restrictions, instruments, etc. ) as shown may alter throughout the course of the development process. Details as shown are a representation only of the information

obtained at the time of searching as interpreted by the author of this report. Calculations and interpretations may vary and must be

Verified by the relevant authorities and bodies.

#### **EXISTING VEGETATION NOTES:-**

Trees of immature height and/or age have not been assessed.

Locations of trees, heights and other significant features are also

More accurate assessment may be required when the final building envelope and proposed works are ascertained.

Refer soil engineer for possible requirement for root barrier/s. assess all significant trees near proposed building envelope.

BELOW DENOTES SIGNIFICANT VEGETATION EXISTING ON

AND/OR AROUND THE SUBJECT SITE AS NOMINATED. ( REFER REPORT ).

W=0-2m ₹ TDia=250mm

**Eucalyptus** H=0-2m HEIGHT: W=0-2m WIDTH:

( Where Determined )

TRUNK DIA: TDia=250mm (MT) MT = MULTIPLE TRUNKS

#### TREE REMOVAL & FOOTINGS NOTE:-

- Any trees from within or around the building envelope should be removed as soon as possible to allow time for the sub-soils to regain their equilibrium moisture content.
- Found footings 2.0 m below ground level if within 0.75 x the mature height of any retained adjacent trees and refer to engineers design
- Alternatively, the proposed structure should be isolated from the drying effect of the trees, by way of a root barrier to



denotes trees / shrubs to be removed

**EXISTING SUBJECT BUILDING** 

**AREA OF PROPOSED WORKS** 



### SITE EXCAVATION:-

No cut or fill proposed to exceed 1m high





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|--|

7	DATE	AMENDMENT DESCRIPTION	ISSUE	Pro
ı	19.02.24	Preliminary working drawing issue	0	ΥM
ı	23.05.24	Add solar panels to roof	Α	Cro
ı				Mt E
3				ATTEN These draw
- 1				(C) CO

ISSUE Proposed Veranda & Deck Extension own Allotment (4B) No. 35 Sunnyside Road, Eliza, Victoria ENTION:
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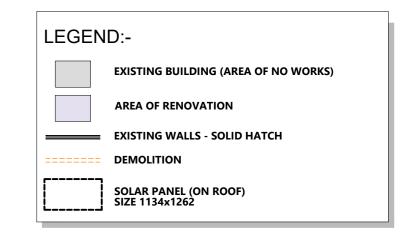
PROPOSED SITE PLAN				
Drawn: FVG	Date: 23.5.202			
Issue No: A	Sheet No: $\triangle \mathcal{Z}$			
Scale: 1:1000	@ A2 Sheet Size			
Job Reference: 3548-CD				



### **PROPOSED FLOOR PLAN**

Scale: 1:100

#### **BUILDING AREA:** M SQ □'S 400.16 43.07 EXISTING BUILDING AREA: EXISTING PORCH(S) 3*Ø.*22 3.25 42.90 EXISTING DECK 4.62 PROPOSED DECK 5*0.*33 5.42 PROPOSED VERANDA 69.60 7.49 TOTAL BUILDING AREA: 523.61 56.36□'S (Total is footprint only and therefore does not include proposed veranda)



# DRAWINGS TO BE READ IN CONJUNCTION WITH STRUCTURAL ENGINEERS DRAWINGS & COMPUTATIONS

Mitchell-Loughrey Consulting Engineers Pty.Ltd.
Graeme Mitchell-0417 594 984 office@mlengineers.com.au
Rob Loughrey-0400 113 291 rob@mlengineers.com.au

#### FOUNDING DEPTHS - Footings:-

FOUND STRIP & STUMP FOOTINGS AT LEAST 100mm INTO
Naturally occurring fine SANDS with an allowable bearing capacity
of 100kPa" AS INDICATED IN THE SOIL REPORT
Soil Report Bore holes indicate founding depths of 300mm &
350mm may be encountered - Verify on site.
SITE CLASSIFICATION: CLASS M

THIS DRAWING SHALL BE READ IN CONJUNCTION WITH SHEETS GN01 - GENERAL NOTES, GN02 - ACCESSIBILITY NOTES.





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	DATE	AMENDMENT DESCRIPTION	ISSUE
	19.02.24	Preliminary working drawing issue	0
	23.05.24	Add solar panels to roof	Α
n			
rs			

Proposed Veranda & Deck Extension

YMCA


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Mt Eliza, Victoria


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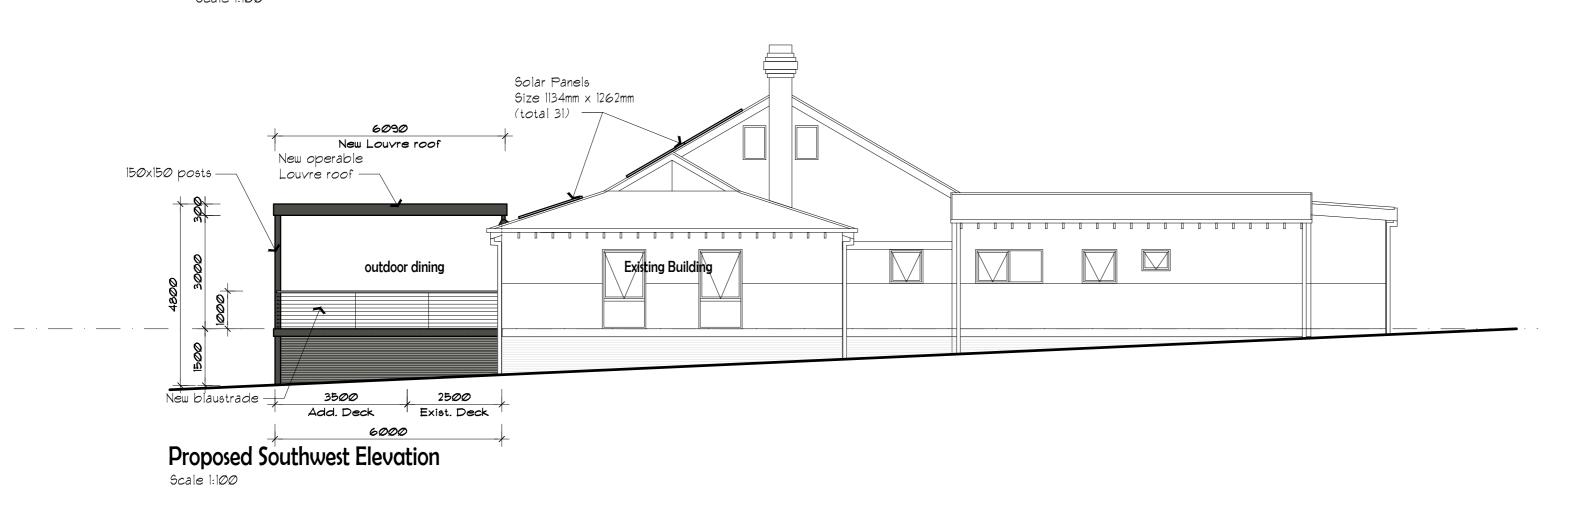
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PROPOSED FI	LOOR PLAN
Drawn: FVG	Date: 23.5.2024
Issue No: A	Sheet No: $\triangle \emptyset 2$
Scale: 1:100	@ A2 Sheet Size
Job Reference: 3548	B-CD





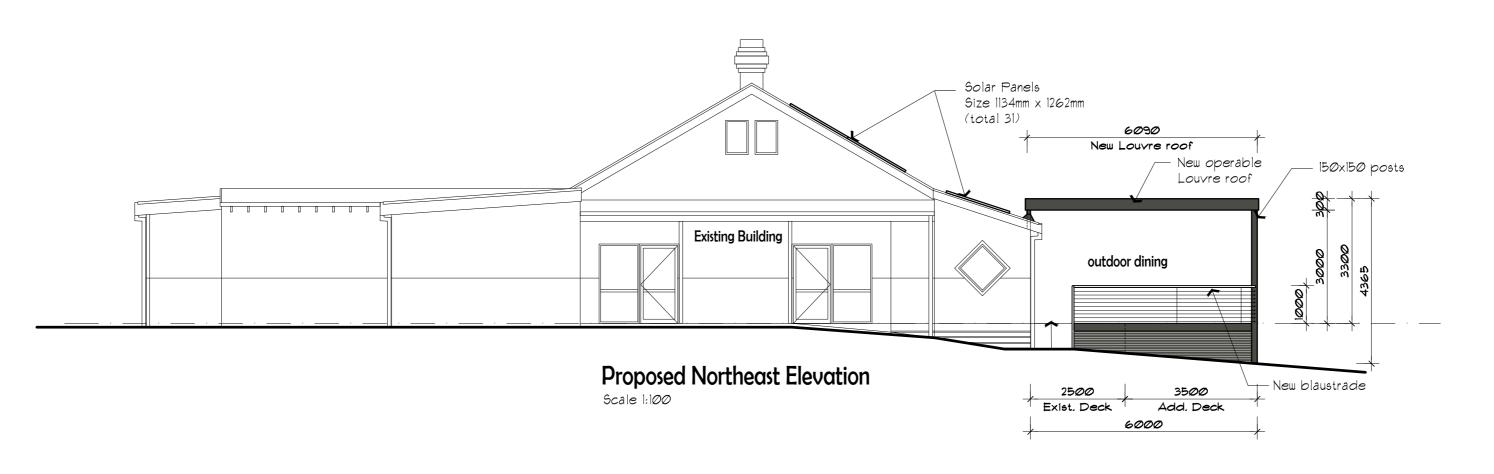

THIS DRAWING SHALL BE READ IN CONJUNCTION WITH SHEETS GN01 - GENERAL NOTES, GNO2 - ACCESSIBILITY NOTES.

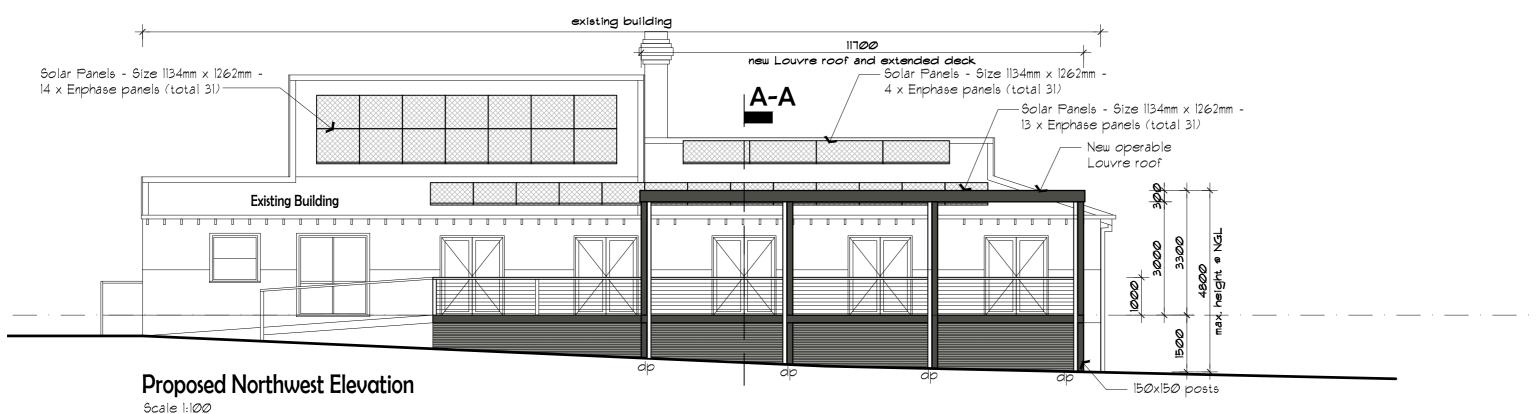FLOOR PLAN LEGEND:-

**Demolition** 

ABE90 Powder

**ABE90 Powder** 

FE-02

**Existing Floor Area - Proposed Renovation** 

New vinyl flooring as Selected by Client

Existing dry powder fire extinguisher for Class A, B C and electrical fires 2.5kg

Existing dry powder fire extinguisher for Class A, B C and electrical fires 4.5kg

**Existing Floor Area - No Works** 

Existing walls - solid hatch

**EXISTING FIRE EXTINGUISHERS:-**

NOT FOR
CONSTRUCTION




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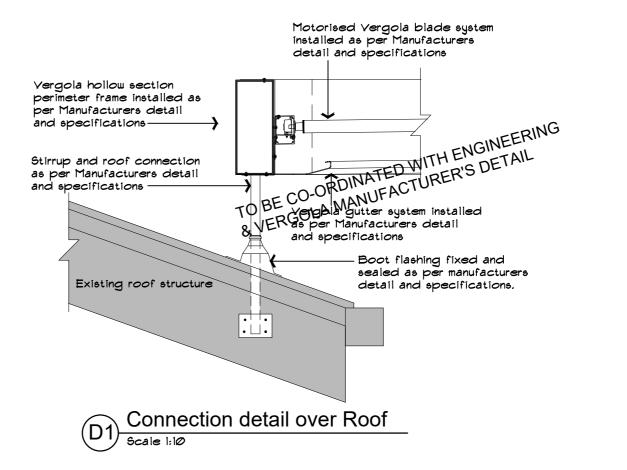
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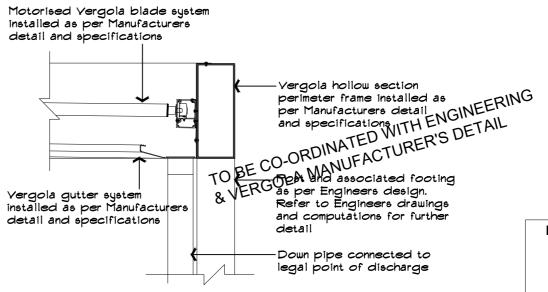
DATE	AMENDMENT DESCRIPTION	ISSUE	Proposed Veranda & Deck Extension	
19.02.24	Preliminary working drawing issue	0	YMCA	
23.05.24	Add solar panels to roof	Α	Crown Allotment (4B) No. 35 Sunnyside Roa	d,
			Mt Eliza, Victoria 3	3930
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PROPOSED E	LEVATIONS
Drawn: FVG	Date: 23.5.2024
Issue No: A	Sheet No: △Ø3
Scale: 1:100	@ A2 Sheet Size
Job Reference: 3548	3-CD



Section A-A



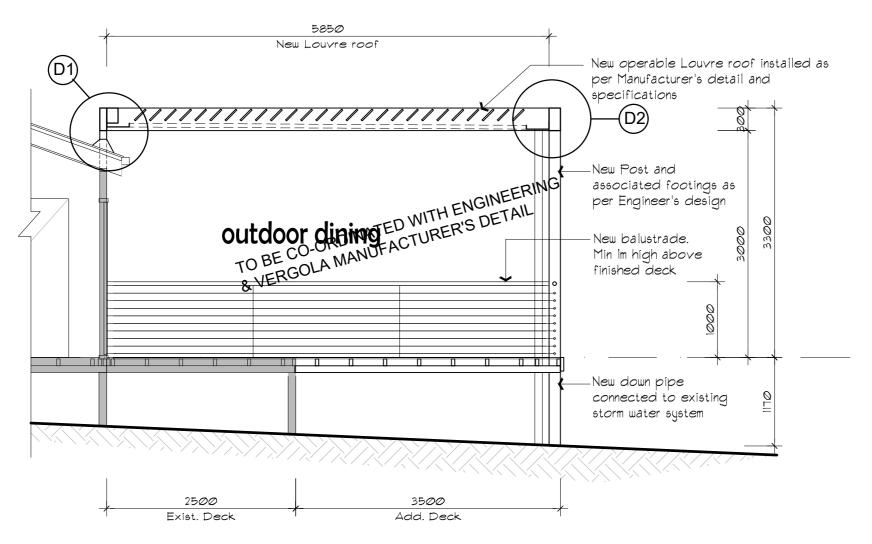

## Vergola gutter Detail

## DRAWINGS TO BE READ IN CONJUNCTION WITH STRUCTURAL ENGINEERS DRAWINGS & COMPUTATIONS

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#### FOUNDING DEPTHS - Footings:-

FOUND STRIP & STUMP FOOTINGS AT LEAST 100mm INTO
Naturally occurring fine SANDS with an allowable bearing capacity
of 100kPa" AS INDICATED IN THE SOIL REPORT
Soil Report Bore holes indicate founding depths of 300mm &
350mm may be encountered - Verify on site.
SITE CLASSIFICATION: CLASS M

THIS DRAWING SHALL BE READ IN CONJUNCTION WITH SHEETS GN01 - GENERAL NOTES, GN02 - ACCESSIBILITY NOTES.





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Design Matters Member

	DATE	AMENDMENT DESCRIPTION	MENT DESCRIPTION ISSUE Proposed Veranda & Deck Ext		
	19.02.24	Preliminary working drawing issue	0	YMCA	
	28.03.24	Building permit RFI's	Α	Crown Allotment (4B) No. 35 Sunnyside Road,	
ı	23.05.24	Add solar panels to roof	В	Mt Eliza, Victoria 3930	
3				ATTENTION: These drawings may not be current or final issue. Look for the building permit approval stamp.  (C) COPRIGHT WARNING This document is protected by federal copyright law. Copyring in any shape or form, in whole or in part, without written authorisation of the registered drafting prostitions; it is right possible build. Call prospections of using damage or promotive may be brought analyst operance found coulong this document without owner.	

PROPOSED SECTION				
Drawn: FVG	Date: 23.5.2024			
Issue No: B	Sheet No: $\triangle \emptyset 4$			
Scale: 1:5Ø	@ A2 Sheet Size			
Job Reference: 3548-CD				